HEALTH SYSTEM ENHANCEMENT PROJECT

TENDER DRAWINGS

Province : Central

District : Kandy

Hospital/PMCU: Central Clinic at Galagedara





MINISTRY OF HEALTH

ADB FUNDED HEALTH SYSTEM ENHANCEMENT PROJECT (HSEP)

RESOURCES DEVELOPMENT CONSULTANTS (PVT) LTD. NO.55-2/1, GALLE ROAD, COLOMBO 03.

ARCHITECTURAL DRAWINGS FOR HEALTH SYSTEMS ENHANCEMENT PROJECT

CENTRAL CLINIC AT GALAGEDARA M.O.H OFFICE KANDY DISTRICT CENTRAL PROVINCE

PROPOSED WAITING AREA EXTENSION AND TOILET BLOCK

CHARTERED ARCHITECT **REGISTRATION No. CA17380**

ARCHITECTS REGISTRATION BOARD GAZETTE REF. No: 2211/46 of 20.01.2021

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MINISTRY OF HEALTH

DESIGN AND SUPERVISION CONSULTANCY FOR INFRASTRUCTURE DEVELOPMENT REP NO.: HSEP/PMU/PROS1/05/2018

R D C RESOURCE DEVELOPMENT CONSULTANTS (Pvt) Ltd. No- 55, 2/1, Galle Road, Colombo 03,

SHEET NO

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TITLE PAGE

DATE

17/05/2022

DRAWING TITLE

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SCALE

DESIGNED & CHECKED BY

DRAWN BY

DC

ADB FUNDED	
HEALTH SYSTEM ENHANCEMENT PROJECT(HSEP)	

CENTRAL CLINIC AT GALAGEDARA M.O.H OFFICE, KANDY DISTRICT, CENTRAL PROVINCE

#	DRAWING NUMBER	DRAWING TITLE	SCALE
01	RDC / HSEP / CTRL / KDY / GLG/ AR-01	TITLE PAGE	_
02	RDC / HSEP / CTRL / KDY /GLG/ AR-02	SCHEDULE OF DRAWINGS	-
03	RDC / HSEP / CTRL / KDY / GLG / AR-03	EXTENSION PLANS	1:100
04	RDC / HSEP / CTRL / KDY / GLG/ AR-04	DETAILS OF NEW WAITING AREA	1:100
05	RDC / HSEP / CTRL / KDY / GLG / AR-05	NEW PATIENTS' TOILET DETAILS	1:50

Archt. K. SAMARAWICKRAMA; AIA(SL)
CHARTERED ARCHITECT
REGISTRATION No. CA17380
ARCHITECTS REGISTRATION BOARD
GAZETTE REF. No: 2211/46 of 20.01.2021



MINISTRY OF HEALTH

ADB FUNDED HEALTH SYSTEM ENHANCEMENT PROJECT(HSEP)


DESIGN AND SUPERVISION CONSULTANCY FOR INFRASTRUCTURE DEVELOPMENT REP NO.: HSEP/PMU/PROS1/05/2018

CENTRAL CLINIC AT GALAGEDARA M.O.H OFFICE, KANDY DISTRICT, CENTRAL PROVINCE



RESOURCE DEVELOPMENT CONSULTANTS (Pvt) Ltd.

DRAWING TITLE	SCHEDULE OF DRAWINGS		DESIGNED & CHECKED BY
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SCALE	DATE 17/05/2022	SHEET NO	DRAWN BY

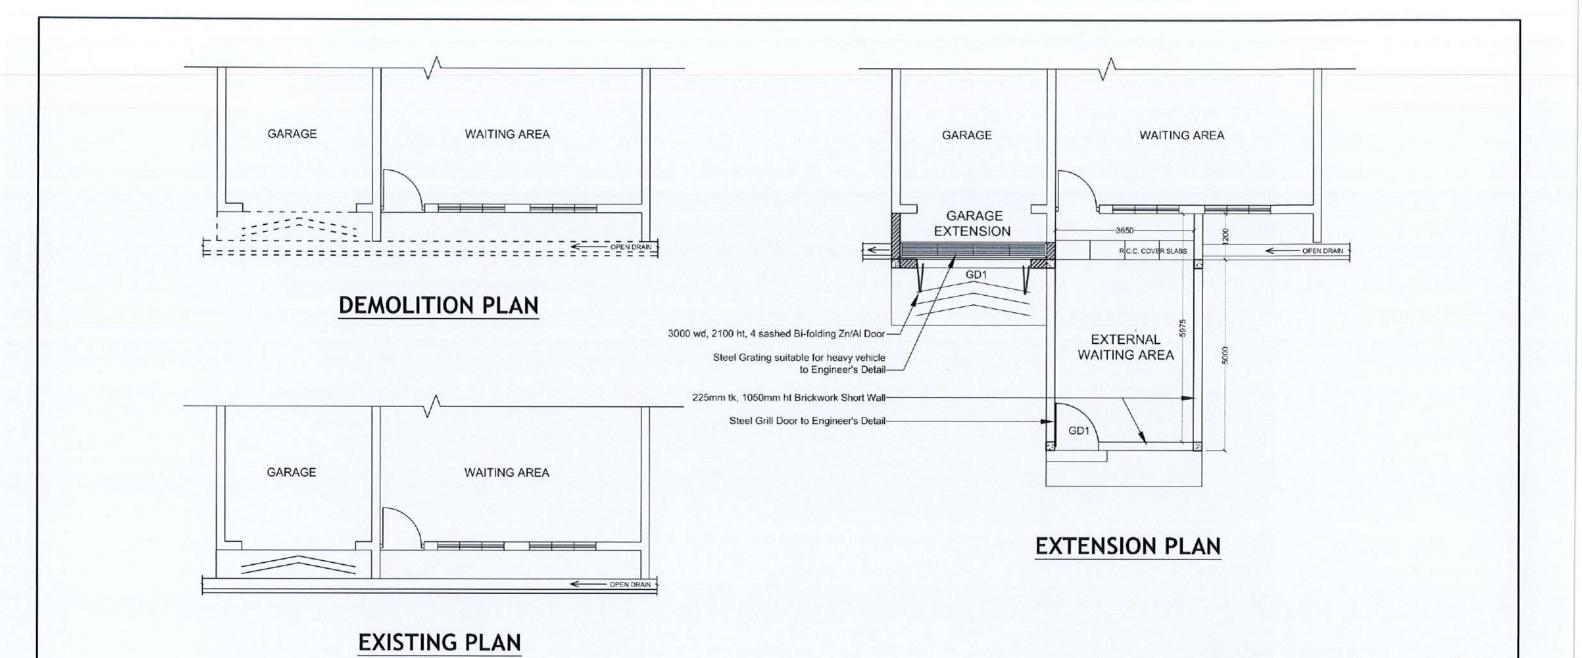




--= DEMOLITION

--= NEW CONSTRUCTION

KEY:


CHARTERED ARCHITECT REGISTRATION No. CA17380

RESOURCE DEVELOPMENT CONSULTANTS (Pvt) Ltd. **DESIGN AND SUPERVISION CONSULTANCY** R D C MINISTRY OF HEALTH No- 55, 2/1, Galle Road, Colombo 03. FOR INFRASTRUCTURE DEVELOPMENT REP NO.: HSEP/PMU/PROS1/05/2018 DESIGNED & CHECKED BY DRAWING TITLE EXTENSION PLANS DRG. NO RDC/HSEP/CTRL/KDY/GLG/ AR-03 CENTRAL CLINIC AT GALAGEDARA M.O.H OFFICE, ADB FUNDED HEALTH SYSTEM ENHANCEMENT PROJECT(HSEP) SCALE SHEET NO DRAWN BY KANDY DISTRICT, CENTRAL PROVINCE 1.100 17/05/2022

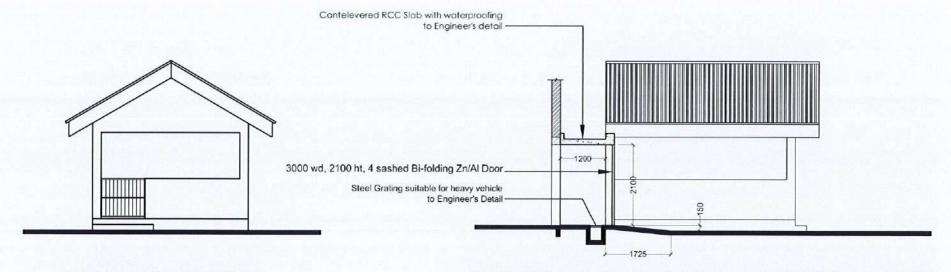


FRONT ELEVATION

SECTIONAL ELEVATION THROUGH GARAGE

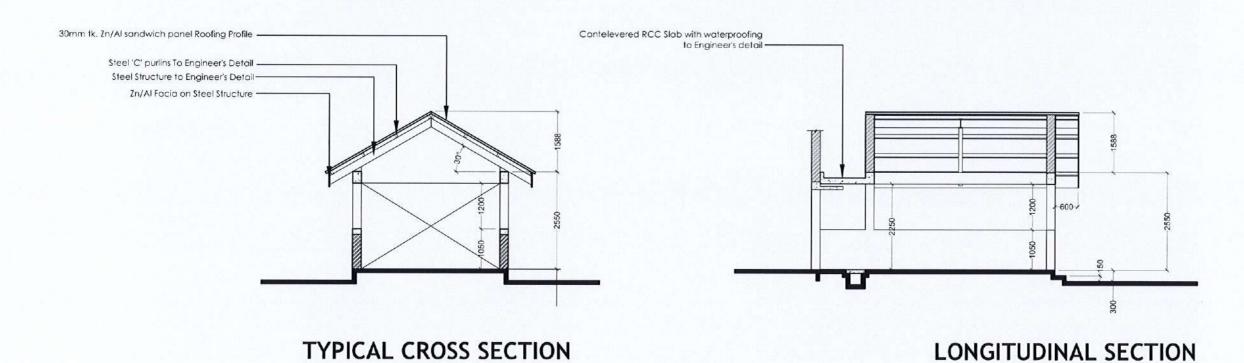

DETAILS OF NEW WAITING AREA



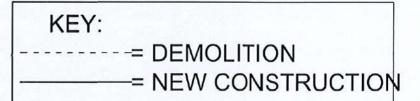

DATE



MINISTRY OF HEALTH

ADB FUNDED HEALTH SYSTEM ENHANCEMENT PROJECT(HSEP)

DESIGN AND SUPERVISION CONSULTANCY FOR INFRASTRUCTURE DEVELOPMENT REP NO.: HSEP/PMU/PROS1/05/2018


CENTRAL CLINIC AT GALAGEDARA M.O.H OFFICE, KANDY DISTRICT, CENTRAL PROVINCE


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RESOURCE DEVELOPMENT CONSULTANTS (Pvt) Ltd.


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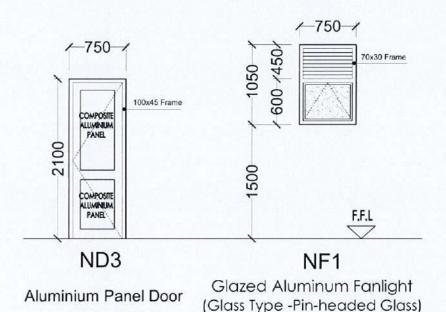
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SIDE ELEVATION



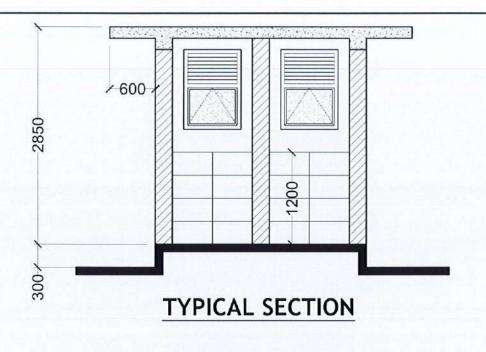

PLAN

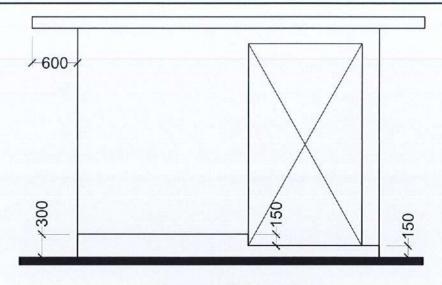- Contractor Must Submit Shop Drawings for All Doors and Windows For Consultant's Approval Before Commencement of any Work.
- 2. Thickness of All Tempered Glass Doors and Windows Should be 12mm
- Glass type for all glazed aliminium Doors and Windows Should be 6mm tk Clear Glass

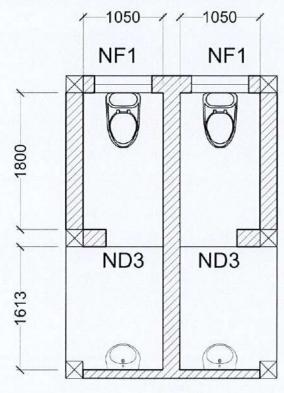- 4. Glass type for Fanlights (type 'F1' & F2) should be 5mm tk 'Pinheaded'
- 5. All Composite Aluminum Panels should be both side coloured (colour to be decided by Architect)

NEW PATIENTS' TOILET

DETAILS

Scale 1:50-

CHARTERED ARCHITECT REGISTRATION No. CA17380 ARCHITECTS REGISTRATION BOARD

DATE



MINISTRY OF HEALTH

DESIGN AND SUPERVISION CONSULTANCY FOR INFRASTRUCTURE DEVELOPMENT REP NO.: HSEP/PMU/PROS1/05/2018

CENTRAL CLINIC AT GALAGEDARA M.O.H OFFICE,



RESOURCE DEVELOPMENT CONSULTANTS (Pvt) Ltd.

No- 55 . 2/1, Galle Road, Colombo 03.

DESIGNED & CHECKED BY NEW PATIENTS' TOILET DETAILS DRG. NO RDC/HSEP/CTRL/KDY/GLG/ AR-05 KS SCALE DRAWN BY SHEET NO 1.50 17/05/2022 DC




ADB FUNDED HEALTH SYSTEM ENHANCEMENT PROJECT(HSEP) KANDY DISTRICT, CENTRAL PROVINCE

HEALTH SYSTEM ENHANCEMENT PROJECT(HSEP) CENTRAL CLINIC AT GALAGEDARA, KANDY DISTRICT CENTRAL PROVINCE

STRUCTURAL LIST OF DRAWINGS				
RAWING NO.	DRAWING TITLE	REV		
S00	COVER SHEET & LIST OF DRAWINGS	00		
S01	GENERAL NOTES	00		
S02	TYPICAL DETAILS	00		
S03	GENERAL ARRANGEMENT OF FOUNDATION DETAILS AND GROUND FLOOR(EXTENSION BUILDING)	00		
S03.1	FOUNDATION DETAILS(EXTENSION BUILDING)	00		
S03.2	GENERAL ARRANGEMENT OF FOUNDATION AND GROUND FLOOR(TOILET BLOCK)	00		
S03.3	GENERAL ARRANGEMENT OF ROOF SLAB (TOILET BLOCK)	00		
S03.4	TYPICAL FOUNDATION DETAILS	00		
S04	GENERAL ARRANGEMENT OF ROOF BEAM AND ROOF(EXTENSION BUILDING)	00		
S04.1	ROOF SECTION	00		
S04.2-4.4	ROOF DETAILS-(1-3)	00		
S05-5.3	CEILING DETAILS	00		

STRUCTURAL DRAWINGS JUNE 2022

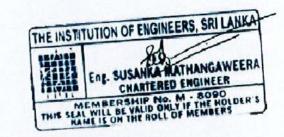

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MINISTRY OF HEALTH

ADB FUNDED HEALTH SYSTEM ENHANCEMENT PROJECT(HSEP)

DESIGN AND SUPERVISION CONSULTANCY FOR INFRASTRUCTURE DEVELOPMENT REP NO.: HSEP/PMU/PROS1/05/2018

CENTRAL CLINIC AT GALAGEDARA M.O.H OFFICE, KANDY DISTRICT, CENTRAL PROVINCE

R D C		EVELOPMENT C No- 55 . 2/1 , Galle Roa		(Pvt) Ltd.	REV.	DESCRIPTION	DATE	
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1. GENERAL NOTES

- 1.1 ALL MATERIALS AND WORKMANSHIP SHALL BE IN ACCORDANCE WITH THE RELEVANT BRITISH OR SRI LANKAN STANDARDS WITH CURRENT AMENDMENTS.
- 1.2 LIME LOADS ARE TAKEN AS PER BRITISH STANDARDS. TOILET ROOF SLAB -

2.0 kN/m2

SUN SHADE SLAB -* FLOOR LOADING AS PER ARCHITECTURAL DRAWING

0.4 kN/m2

- 1.3 ROOF LIVE LOAD -1.4 THE DETAILS SHOWN ON DRG. NO. SO2 DESIGNATED AS "TYPICAL DETAILS". APPLY GENERALLY TO THE DRAWNOS IN ALL AREAS WHERE CONDITIONS ARE SMILAR TO THOSE DESCRIBED IN THE DETAILS, UNLESS NOTED OTHERWISE.
- 1.5 THE HORIZONTAL AND VERTICAL DIMENSIONS OF THE STRUCTURE SHALL BE VERIFIED DURING CONSTRUCTION. ANY VARIATIONS OR DISCREPANCIES IN THE DIMENSIONS SHALL BE BROUGHT TO THE CONSULTANT'S ATTENTION IMMEDIATELY.
- 1.6 ALL DIMENSIONS ARE IN MILIMETERS, UNO, DO NOT SCALE DRAWINGS.
- 1.7 THE CONTRACTOR SHALL CO-ORDINATE THE STRUCTURAL DETAILS WITH THE ARCHITECTURAL DETAILS AND WITH OTHER DISCIPLINES SUCH AS MECHANICAL. ELECTRICAL AND PLUMBING, REPORT CONFLICTS OR DISCREPANCIES TO THE CONSULTANT PRIOR TO FABRICATING, INSTALLING OR CONSTRUCTING STRUCTURAL

 - b. SIZE AND LOCATION OF ALL CONCRETE KERBS, FLOOR DRAINS, SLOPES, DEPRESSED AREAS, CHANGES IN LEVELS, CHANFERS, GROOVES, INSERTS, ETC. c. SIZE AND LOCATION OF ALL FLOOR AND ROOF OPENINGS.
 - d. DIMENSIONS NOT SHOWN ON STRUCTURAL DRAWINGS.
 - SEE MECHANICAL, PLUMBING AND ELECTRICAL DRAWINGS FOR THE FOLLOWING
 - a. PIPE RUNS, SLEEVES, HANGERS, TRENCHES, WALL, ROOF AND FLOOR OPENINGS, ETC. NOT SHOWN OR NOTED.
 - b. ELECTRICAL CONDUIT RUNS, BOXES, OUTLETS IN WALLS AND SLABS.
 - c. ANCHORACE AND BRACING FOR ELECTRICAL, MECHANICAL OR PLUMBING
 - d. ANCHOR BOLTS FOR MOTOR MOUNTS.
 - e. SIZE AND LOCATION OF MACHINE AND EQUIPMENT BASES.
- 1.8 OPENINGS, POCKETS, ETC. SHALL NOT BE PLACED IN STRUCTURAL MEMBERS UNLESS SPECIFICALLY DETAILED ON THE STRUCTURAL DRAWINGS. WHEN DRAWINGS BY OTHERS SHOW OPENINGS, POCKETS ETC., NOT SHOWN IN STRUCTURAL DRAWINGS, BUT WHICH ARE LOCATED IN STRUCTURAL MEDIBERS, SUCH ITEMS SHALL BE BROUGHT TO THE CONSULTANT'S ATTENTION FOR APPROVAL PRIOR TO FABRICATION OR CONSTRUCTION
- 1.9 THE CONTRACT DOCUMENTS REPRESENT THE FINISHED STRUCTURE. THEY DO NOT INDICATE THE METHOD OF CONSTRUCTION. THE CONTRACTOR SHALL PROMOE AND BURLINGSEONESPHIRSBEL FURH AMEAGURESPASSIVALE CHISALARS. TO FURH AMEAGURES RESIDIATE CHISALARS. TO FURH AMEAGURES RESIDIATE CHISALARS.
- BRACING, SHORING, FORM WORK, PROPS, AND SEQUENCING OF THE REMOVAL OF THE
- 1.10 THE CONTRACTOR SHALL ENSURE THAT ALL CONSTRUCTION LOADS DO NOT EXCEED THE DESIGN LIVE LOADS INDICATED ABOVE AND THAT THESE LOADS ARE NOT PUT ON STRUCTURAL MEMBERS PRIOR TO THE TIME THAT THE CONCRETE REACHES THE FULL
- 1.11 LOADING FOR NECHANICAL ROOMS ARE BASED ON ASSUMED WEIGHTS OF EQUIPMENT as indicated on the mechanical drawings (including the weight of concrete pads, where indicated) any changes in type, size, or number of pieces of equipment shall be reported to the consultant for verification of the ADEQUACY OF SUPPORTING MEMBERS PRIOR TO THE PLACEMENT OF SUCH EQUIPMENT.
- 1.13 CONTRACTOR SHALL BE RESPONSIBLE FOR PREPARING AND SUBMITTING FOLLOWING DOCUMENTS FOR THE CONSULTANT'S APPROVAL AT LEAST EIGHT WEEKS PRIOR TO THE
 - O. METHOD STATEMENT FOR THE WORK
 - b. CO-ORDINATION DRAWINGS.
 - c. SHOP DRAWINGS (FOR FORM WORK, MASONRY WORK INCLUDING THE STIFFENER COLUMN/BEAM ARRANGEMENT, ZINCALUME ROOFING SYSTEM INCLUDING FRAME
 - d. BAR-BENDING SCHEDULES FOR R.C. WORKS.
 - e. CONSTRUCTION DRAWINGS FOR ALL TEMPORARY WORKS.
 - f. Drawings for pouring patterns, casting sequence, construction joints etc.

2. FOUNDATION NOTES

2.1 FOUNDATION HAS BEEN DESIGNED BASED ON PRESUMPTIVE BEARING CAPACITY OF 125KN/m2.

> CONTRACTOR SHALL VERIFY THE FOUNDATION BEARING SOIL CONDITION TO ENGINEER BEFORE COMMENCEMENT OF CONSTRUCTION

3. CONCRETE WORK

- 3.1 ALL CONCRETE WORK SHALL BE IN ACCORDANCE WITH BS 8110, BS 8007 AND
- 3.2 CONCRETE TESTING SHALL BE IN ACCORDANCE WITH BS 5328, UNLESS OTHERWISE
- 3.3 ALL CONCRETE SHALL BE READYMIX AND SUPPLIED ACCORDING TO THE APPROVED
- 3.4 CONCRETE IN THE FOLLOWING AREAS SHALL HAVE SAND AND CRUSHED STONE AGGREGATES, ORDINARY PORTLAND CEMENT PROPORTIONED TO PRODUCE A DENSE WORKABLE MIX WHICH CAN BE PLACED WITHOUT SEGREGATION OR EXCESS FREE SURFACE WATER. IT SHALL ALSO HAVE THE PROPERTIES INDICATED BELOW.
 - a. CONCRETE CRADE FOR REINFORCED CONCRETE WORK SHALL BE AS FOLLOWS WITH MAXIMUM AGGREGATE SIZE 20mm UNLESS NOTED OTHERWISE.

FOUNDATION, COLUMNS, BEAMS & SLABS - C25

- b. ALL CONCRETE FOR CONCRETE SCREED SHALL BE GRADE 15. c. CONCRETE FOR THE STIFFENER COLUMNS & LINTELS TO BE GRADE 25.
- 3.5 COVER TO REINFORCEMENT
 - FOUNDATION 50mm
 - COLUMN BELOW GROUND 50mm
 - COLUMN ABOVE GROUND 30mm
 - BEAMS 30mm

 - SLAB BOTTOM 25mm
 - STIFFENER COLUMNS & LINTEL BEANS 25mm
- 3.6 MIX DESIGNS SHALL BE PREPARED AND SUBMITTED BY THE CONTRACTOR FOR APPROVAL TO THE CONSULTANT. THE CONTRACTOR SHALL SUBMIT RESULTS OF TRIAL MIXES CRADING CURVES AND ALL OTHER DETAILS TO ENABLE THE CONSULTANT TO EVALUATE
- 3.7 ALL CONCRETE SHALL CONTAIN AN APPROVED WATER-REDUCING, CEMENT DISPERSING ADMIXTURE CONFORMING TO ASTM C494, TYPE A, D, E, F, OR G.
- 3.8 CONCRETE SHALL BE WELL COMPACTED BY MECHANICAL MEANS WITHOUT SEGREGATION.
- 3.9 CONCRETE GRADE AT THE COLUMN/BEAM JUNCTION TO BE EQUAL TO THE GRADE OF THE COLUMN CONCRETE.
- 3.10 ALL CONCRETE SURFACES, EXCEPT THOSE COVERED BY FORM WORK, SHALL BE CURED TO THE SATISFACTION OF THE CONSULTANT. (COST OF CURING SHALL BE
- 3.11 ALL GRADE BEAMS AND SLABS SHALL BE FORMED ON SIDES UNLESS SHOWN
- 3.12 CONCRETING OF SLABS-ON-GRADE (GROUND SLABS, OTHER THAN RAFT) SHALL BE PLACED IN BAYS WHERE LENGTHS AND WIDTHS DO NOT EXCEED SIX METRES UNLESS APPROVED BY THE CONSULTANT.
- 3.13 CONTRACTOR SHALL SUBMIT CONSTRUCTION JOINT LAYOUT, POURING PATTERN AND CASTING SEQUENCE FOR APPROVAL OF THE CONSULTANT AT LEAST EIGHT WEEKS PRIOR TO THE POURING OF CONCRETE.
- 3.14 ALL BEAM VERTICAL CONSTRUCTION JOINTS SHALL BE MADE AT ONE THIRD OF THE SPAN POINTS USING VERTICAL BULKHEADS WITH SHEAR KEYS AND DOWELS.(WHEN PRIMARY BEAM SHALL BE OFFSET A DISTANCE EQUAL TO TWICE THE WIDTH OF THE BEAW). THE LOCATION OF CONSTRUCTION JOINTS SHALL BE APPROVED BY THE
- 3.15 HORIZONTAL CONSTRUCTION JOINTS SHALL BE PERMITTED ONLY WHERE SHOWN IN THE STRUCTURAL DRAWINGS OR APPROVED BY THE CONSULTANT. HORIZONTAL OR NEARLY HORIZONTAL JOINTS SHALL BE PREPARED BY ROUGHENING THE SURFACE IN AN APPROVED MANNER SO THAT THE AGGREGATES ARE EXPOSED UNIFORMLY, LEAVING NO LATANCE, LOOSE PARTICLES OR DAMAGED CONCRETE.
- 3.16 EXCEPT AS DETAILED ON STRUCTURAL DRAWINGS, NO SLABS, OR BEAARS, SHALL BE SLEEVED FOR PIPING OR DUCTS, UNLESS APPROVED BY THE CONSULTANT.
- 3.17 WHERE CONDUITS RUN IN SLARS, THEY SHALL BE POSITIONED AT NID-DEPTH OF SLAB. CONDUIT SIZE SHALL NOT EXCEED 33 PERCENT OF THE SLAB DEPTH. NO CONDUIT SHALL BE PLACED IN SLABS WITH ACTUAL CONCRETE THICKNESS LESS THAN 75mm (3 in). THERE SHALL BE A MINIMUM OF 75mm (3 in) OF CLEAR SPACE BETWEEN CONDUITS. ALUMINIUM CONDUITS ARE PROHIBITED. PLACE CHARS OF 10 mm (3/8 in) DM.
 STEEL PERPENDICULAR TO THE CONDUIT PATH. THE ADDED R/F SHALL EXTEND 400mm (16 in) ON BOTH SIDES AND SPACING OF THE ADDED R/F TO BE 600 - 800 mm (24 - 32 in)
- 3.18 PROVIDE CHAMFERS AS SPECIFIED AND AS DETAILED ON ARCHITECTURAL/STRUCTURAL
- 3.19 ALL FOREIGN MATERIAL SHALL BE ENTIRELY REMOVED FROM FORMS PRIOR TO PLACING OF CONCRETE. ANY DEFECTS IN THE HARDENED CONCRETE SHALL BE CONSULTANT. THE CONTRACTOR SHALL REMOVE AND REPLACE ANY CONCRETE WHICH
- 3.20 MINIMUM FREE FALL OF CONCRETE SHOULD BE LIMITED TO 1.5m (5 ft) DURING THE PLACEMENT OF CONCRETE. IN THE EVENT LIFT HEIGHT IS CREATER THAN 1.5m (5 ft), A TREME PIPE OR SIMILAR APPROVED ARRANGEMENT SHOULD BE USED. CASTING OF COLUMNS TOGETHER WITH SLABS AND BEAMS WILL NOT BE ALLOWED.

4. FORM WORK

- 4.1 FORM WORK SHOULD COMPLY WITH BS 8110 AND BS 5975.
- 4.2 REMOVE ALL PROPS AND FORM WORK OF SLABS AND BEAMS BEFORE CONSTRUCTING WALLS ABOVE THE PARTICULAR LEVEL.
- 4.3 DO NOT REMOVE FORM WORK OR PROPS BEFORE CONCRETE GAINS SUFFICIENT STRENGTH SPECIFIED IN RELEVANT STANDARDS, UNDER ANY CIRCUIASTANCE
 - MAINTAIN ALL FORM WORKS FOR SLABS FOR A MINIMUM OF 7 DAYS
 - MUNTAIN ALL PROPS FOR ADDITIONAL 14 DAYS.
- MAINTAIN COLUMN FORM WORK FOR A MINIMUM OF 7 DAYS IF A SPECIAL CURING PROCEDURE IS NOT USED. 4.4 ALL DEBRIS SHALL BE ENTIRELY REMOVED FROM FORMS PRIOR TO PLACING OF CONCRETE.

5. REINFORCEMENT STEEL NOTES

- 5.1 ALL REINFORCING STEEL SHALL COMPLY WITH BS 4449 GRADE 460 HIGH YIELD DEFORMED TYPE 2 BARS OR GRADE 250 MILD STEEL, USE OF REINFORCEMENT FOR THE WORK WILL BE CONSIDERED ONLY UPON SUBMITTAL OF RELEVANT INFORMATION TO THE CONSULTANT FOR APPROVAL SUBMITTALS SHALL INCLUDE MILL CERTIFICATES OR OTHER RECOGNISED CERTIFICATIONS CLEARLY INDICATING THE MATERIAL COMPOSITION, YELD STRENGTH, ULTIMATE STRENGTH, AND BAR BEND TEST. THE CONSULTANT MAY ORDER ADDITIONAL TESTS TO BE CARRIED OUT, AS MAY BE REQUIRED, THE COSTS OF WHICH SHALL BE BORNE BY THE CONTRACTOR
- 5.2 NO REINFORCING BARS SHALL BE WELDED, UNLESS SPECIFICALLY NOTED OR APPROVED BY THE CONSULTANT.
- 5.3 MINIMUM CONCRETE COVER FOR REINFORCEMENT SHALL BE AS NOTED BELOW,
 - 0. CONCRETE SURFACES PROTECTED AGAINST WEATHER OR AGGRESSIVE CONDITION
 - b. CONCRETE SURFACES EXPOSED TO RAIN OR ALTERNATE WETTING AND DRYING CONTINUOUSLY UNDER WATER - 40 mm AND CONTACT WITH SOIL - 50mm
- 5.4 REINFORCING BARS SHOULD BE LAPPED ONLY AS SHOWN ON THE DRAWINGS.
- 5.5 PROVIDE CONCRETE COVER BLOCKS OR STANDARD BAR CHAIRS WITH PROTECTIVE TPS AND SPACEDS SPACED AS REQUIRED TO PROVIDE SPECIFIED CONCRETE PROTECTION FOR REINFORCEMENT BUT NOT TO EXCEED 900mm (35") ON CENTRE FOR ALL SLABS, AND BEALS, PLACE BAR CHAIRS OR COVER BLOCKS LONGITUDINALLY IN ALL BEAMS DIRECTLY BELOW THE STIRRUPS. BAR SHALL BE TIED IN PLACE WITH 16 GAUGE DOUBLED-ANNEALED IRON WIRE.


BAR NOTATIONS

R - MLD STEEL OF CHARACTERISTIC STRENGTH OF 250 N/mm TO BS 4449 Y - HIGH YIELD STEEL OF CHARACTERISTIC STRENGTH OF 460 N/mm TO BS 4449

BAR LOCATION BAR SPACING T - TOP REINFORCEMENT(T1-OUTER,T2-INNER) B - BOTTOM REINFORCEMENT(B1-OUTER,B2-INNER)

BAR DUAMETER FF - FAR FACE REINFORCEMENT BAR TYPE 'Y' OR 'R' BF - BOTH FACE REINFORCEMENT NUMBER OF BARS

- FL FULL LENGTH (12 m LONG) ALT - ALTERNATE BAR STG - STAGGERED
- 5.7 FABRICATION OF REINFORCEMENT SHALL COMPLY WITH BS 4466
- 5.8 TYPICAL LAPPING AND CRANKING DETAIL (UNLESS OTHERWISE INDICATED)

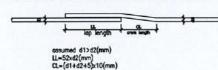

6. MASONRY

- 6.1 MASONRY WORK SHALL COMPLY WITH BS 6073.
- 6.2 ALL MASONRY WALLS SHALL BE NON LOAD BEARING TYPE UNLESS OTHERWISE SPECIFIED.
- ALL NON LOAD BEARING WALLS SHALL BE ISOLATED FROM THE MAIN STRUCTURE BY PROVIDING A 10mm (3/8") CLEARANCE BETWEEN THE WALL AND THE SIDES.
- 6.4 ALL MASONRY WORK SHALL BE WITH HOLLOW CEMENT BLOCKS UNLESS SPECIFIED
- 6.5 MINIMUM STRENGTH OF MASONRY SHALL BE 1.2MPa.
- 6.6 PROPORTIONS OF CONSTITUENTS OF MORTAR FOR MASONRY WORK SHALL BE AS GYEN IN SPECIFICATION FOR BLOCKWORK.

7. STRUCTURAL STEEL

- 7.1 STEEL WORK SHALL BE IN ACCORDANCE WITH BS 5650. UNLESS NOTED OTHERWISE, ALL STEEL SHALL BE OF GRADE 43 AND COUPLY WITH BS 4360.
- 7.2 STRUCTURAL STEEL DESIGNATED ON DRAWINGS IS BASED ON SCITIONS FOUND IN 85 4848. EQUIVALENT METRIC SIZES HAVE BEEN INDICATED. ALL SECTIONS SELECTED SHALL HAVE PROPERTIES EQUAL TO OR CREATER THAN THE SECTIONS.
- 7.3 UNLESS NOTED OTHERWISE, ALL BOLTS SHALL BE OF GRADE 8.8 AND SHALL COMPLY WITH BS 4190. ALL BOLTS OF UP TO 22mm DAMETER SHOULD HAVE A 2mm CLEARANCE AND A 3mm CLEARANCE FOR LARGER BOLTS.
- 7.4 THE MINIMUM CONNECTION SHALL BE WITH TWO BOLTS OF GRADE 8.8 AND OF 22mm DIAMETER SUBJECTS TO SINGLE
- WELDING SHALL BE CARRED OUT BY A QUALIFIED WELDER, IN ACCORDANCE WITH BS 5950. FILLET WELDS TO BE CONTINUOS AND BUTT WELDS TO BE FULLY PENETRATED, UNLESS NOTED OTHERWISE.
- INCREASE WELD SIZES FROM MINIMUM VALUES GYEN IN DRAWNGS, DEPENDING ON THE THICKNESS OF PLATES THAT ARE WELDED. THE MINIMUM WELD SIZES FROM MINIMUM VALUES GYEN IN DRAWNISS, DEPENDING ON THE THICKNESS OF PLATES THAT OWNERS, DEPENDING ON THE THICKNESS OF PLATES THAT WOULD BE WELDED.
- 7.7 ALL WELDS SHALL BE DONE WITH ELECTRODES TO HAVE A MINIMUM STRENGTH OF 430. MPG, COMPLYING WITH BS 639.
- 7.8 WELDING PROCEDURES SHALL BE SUBMITTED FOR ENGINEER'S TESTING AGENCY TO REVIEW BEFORE COMMENCING ANY PARRICATION OR EXECTION. ALL COMPLETE PRINCIPATION WILLIAM SHALL BE TRANSONIOLIZED ACCORDING TO SECTIONATIONS IN 85 639 AND WITH THE APPROVAL OF CONSULTANT.
- 7.9 CUSSET PLATES TO BE 10mm THICK, UNLESS OTHERWISE HOTED.
- STEEL SHALL BE CLEANED TO BRIGHT WETAL BY ABRASIVE BLAST OR EQUIVALENT TO CLASS 2 FINISH, TO BS EN ISO 1461. THE PAINTING SYSTEM SHALL BE AS PER THE SPECIFICATION.
- 7.11 THREE COPIES OF WORKSHOP DRAWINGS SHOULD BE SUBMITTED TO THE CONSULTANT. FOR APPROVAL, PROOF TO START ANY FABRICATION.
- STEEL SECTIONS INDICATED IN THE DRAWING ARE STANDARD SECTIONS CONTRACTOR SHALL BID CONFIRMING THE AVAILABLE STEEL SECTIONS IN THE MARKETING ADDITIONAL COST WILL BE PAID DUE TO THE NON-AVAILABILITY OF THE SPECIFIED SECTIONS.
- 7.13 ALL STEEL MEMBERS TO BE SAND BLASTED AND APPLIED WITH PAINTING SYSTEMS SPECIFIED.

8. ERECTION

- This building wust be erected according to the erection drunings and safe erection practices. Designer is not responsible for any structural inadequacy or 000 appearance if the above requirement is not followed.
- 8.2 GUSSET PLATES FOR FLANCE BRACES ARE WELDED ON BOTH SIDES OF THE COLUMN AND RAFTER-HOWEVER FLANCE BRACES ARE REQUIRED AT ONE SIDE (UNLESS NOTED OTHERWISE). IT IS PREFERABLE TO INSTALL THEM ALL AT THE SAME SIDE OF THE COLUMN AND RAFTER THE SIDE CHOSEN DEPOIONS ON ERECTION SEQUENCE.
- 8.3 CONTRACTOR SHALL PRODUCE SHOP DRAWINGS FOR CONSULTANTS APPROVAL BEFORE FABRICATIONS.
- 8.4 ALL COPES, HOLES, OPDINGS AND MODIFICATIONS REQUIRED IN STRUCTURAL STEEL MEMBERS FOR ERECTION OR THE WORK OF OTHER TRADES SHALL BE SHOWN ON THE SHOP DRAWINGS FOR APPROVAL BY THE ARCHITECT AND STRUCTURAL ENGINEERS.
- 8.5 FIELD MODIFICATION OF STRUCTURAL STEEL IS PROHIBITED WITHOUT PRIOR APPROVAL OF THE ARCHITECT AND STRUCTURAL

LEGEND

LOAD BEARING REINFORCED CONCRETE

BRICK/BLOCK WORK IN SECTION

NON REINFORCED CONCRETE (LEAN CONCRETE)

STRUCTURAL SUPPORT BELOW



ABBREVIATIONS

DIAMETER REINFORCED CONCRETE REINFORCEMENT

THE INSTITUTION OF ENGINEERS, SRI LANKA Eng. SUSANKA MATHANGAWEERA CHARTERED ENGINEER THIS SEAL WILL BE VALID ONLY IF THE HOLDER'S HAME IS ON THE ROLL OF MEMBERS



MINISTRY OF HEALTH

ADB FUNDED HEALTH SYSTEM ENHANCEMENT PROJECT(HSEP) **DESIGN AND SUPERVISION CONSULTANCY** FOR INFRASTRUCTURE DEVELOPMENT

REP NO.: HSEP/PMU/PROS1/05/2018

CENTRAL CLINIC AT GALAGEDARA M.O.H OFFICE. KANDY DISTRICT, CENTRAL PROVINCE





RESOURCE DEVELOPMENT CONSULTANTS (Pvt) Ltd.


No- 55, 2/1, Galle Road, Colombo 03.


DATE DESCRIPTION


DESIGNED BY CHECKED BY GENERAL NOTES DRAWING TITLE RDC / HSEP / CTRL / KDY / GLG /S00 DRG. NO SH SCALE DRAWN DRAFTING CHECK DATE SHEET NO AZAD 29/6/2022 LAL AS GIVEN S01

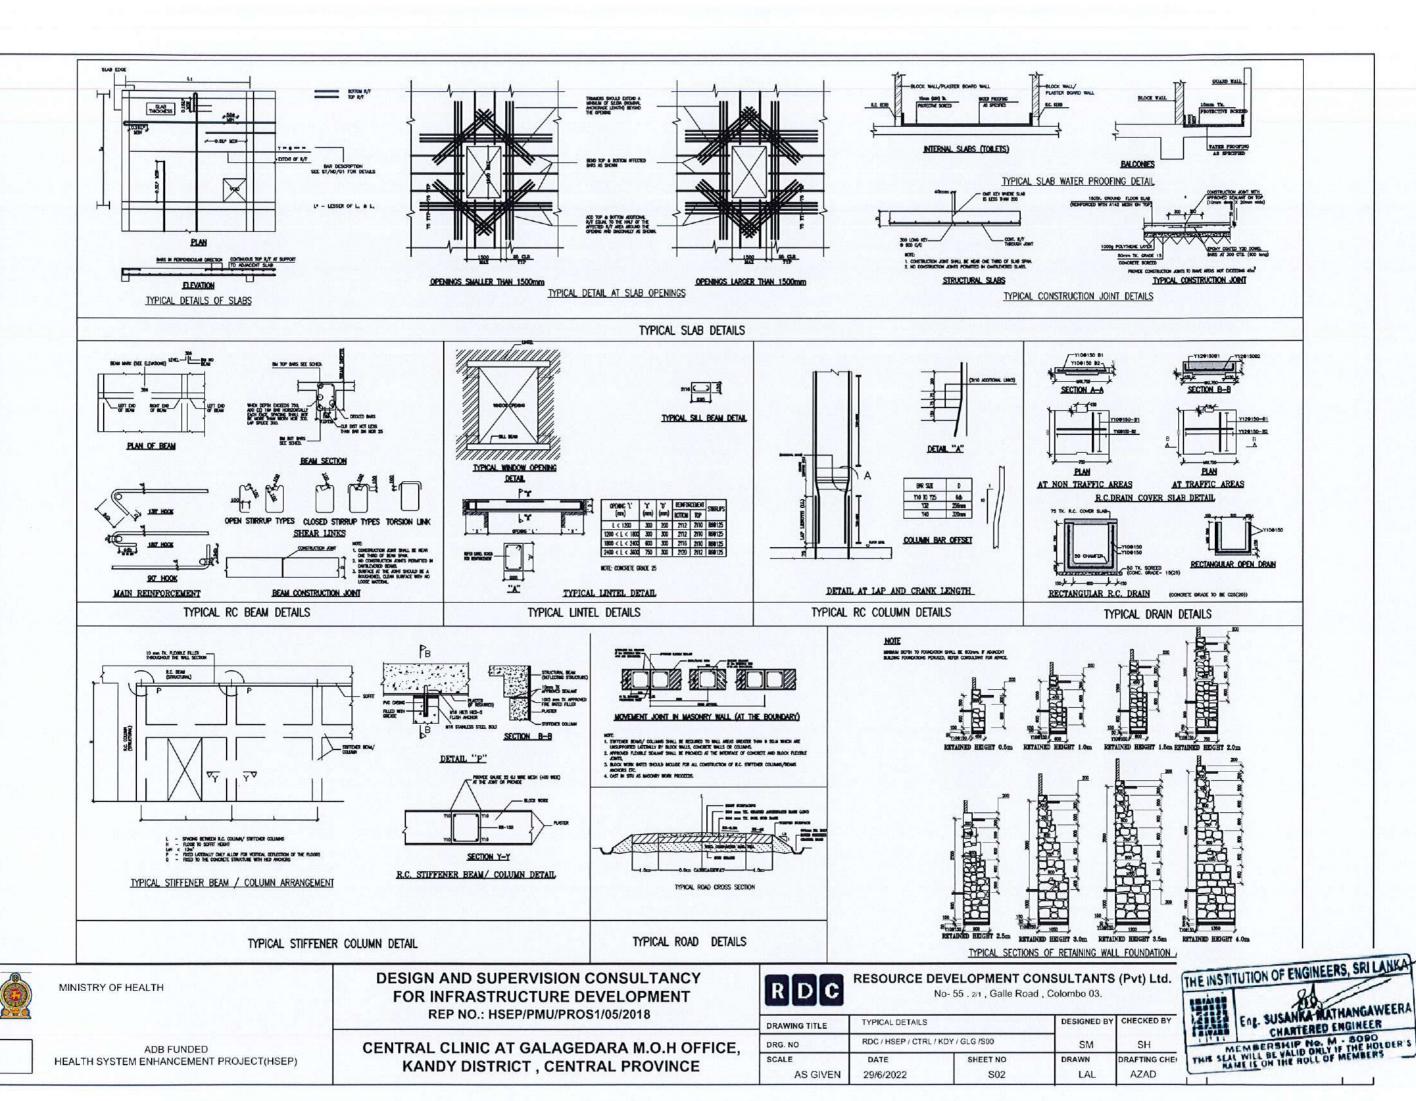

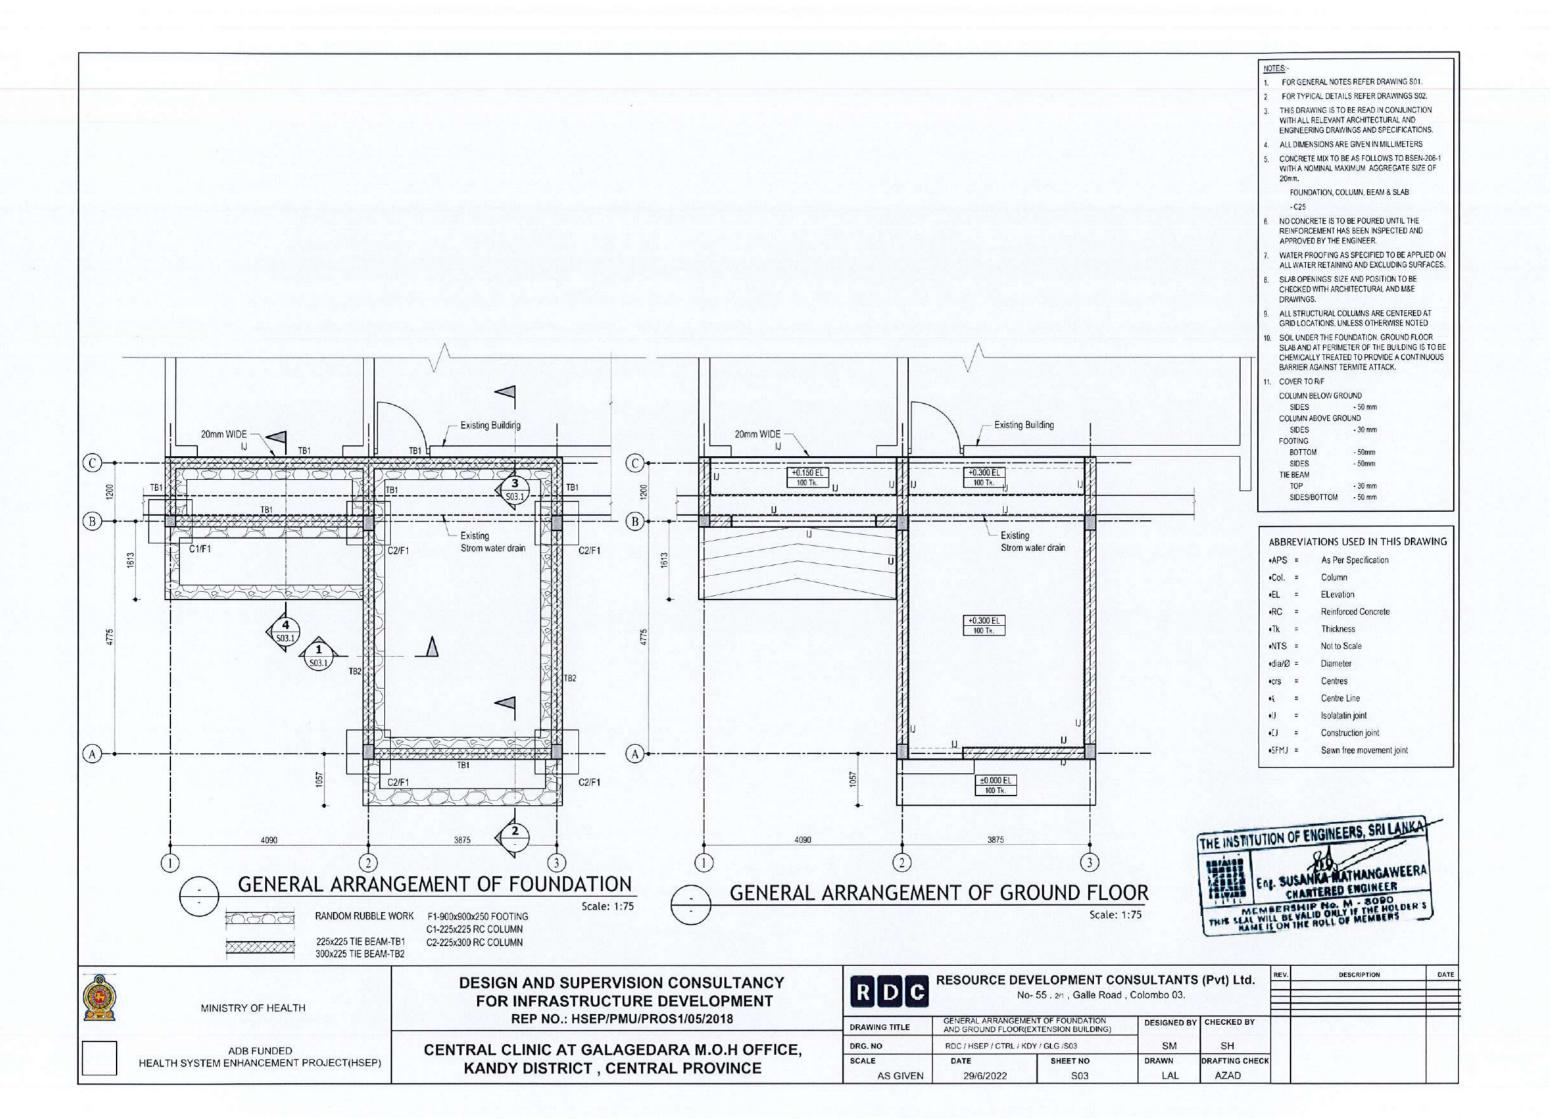

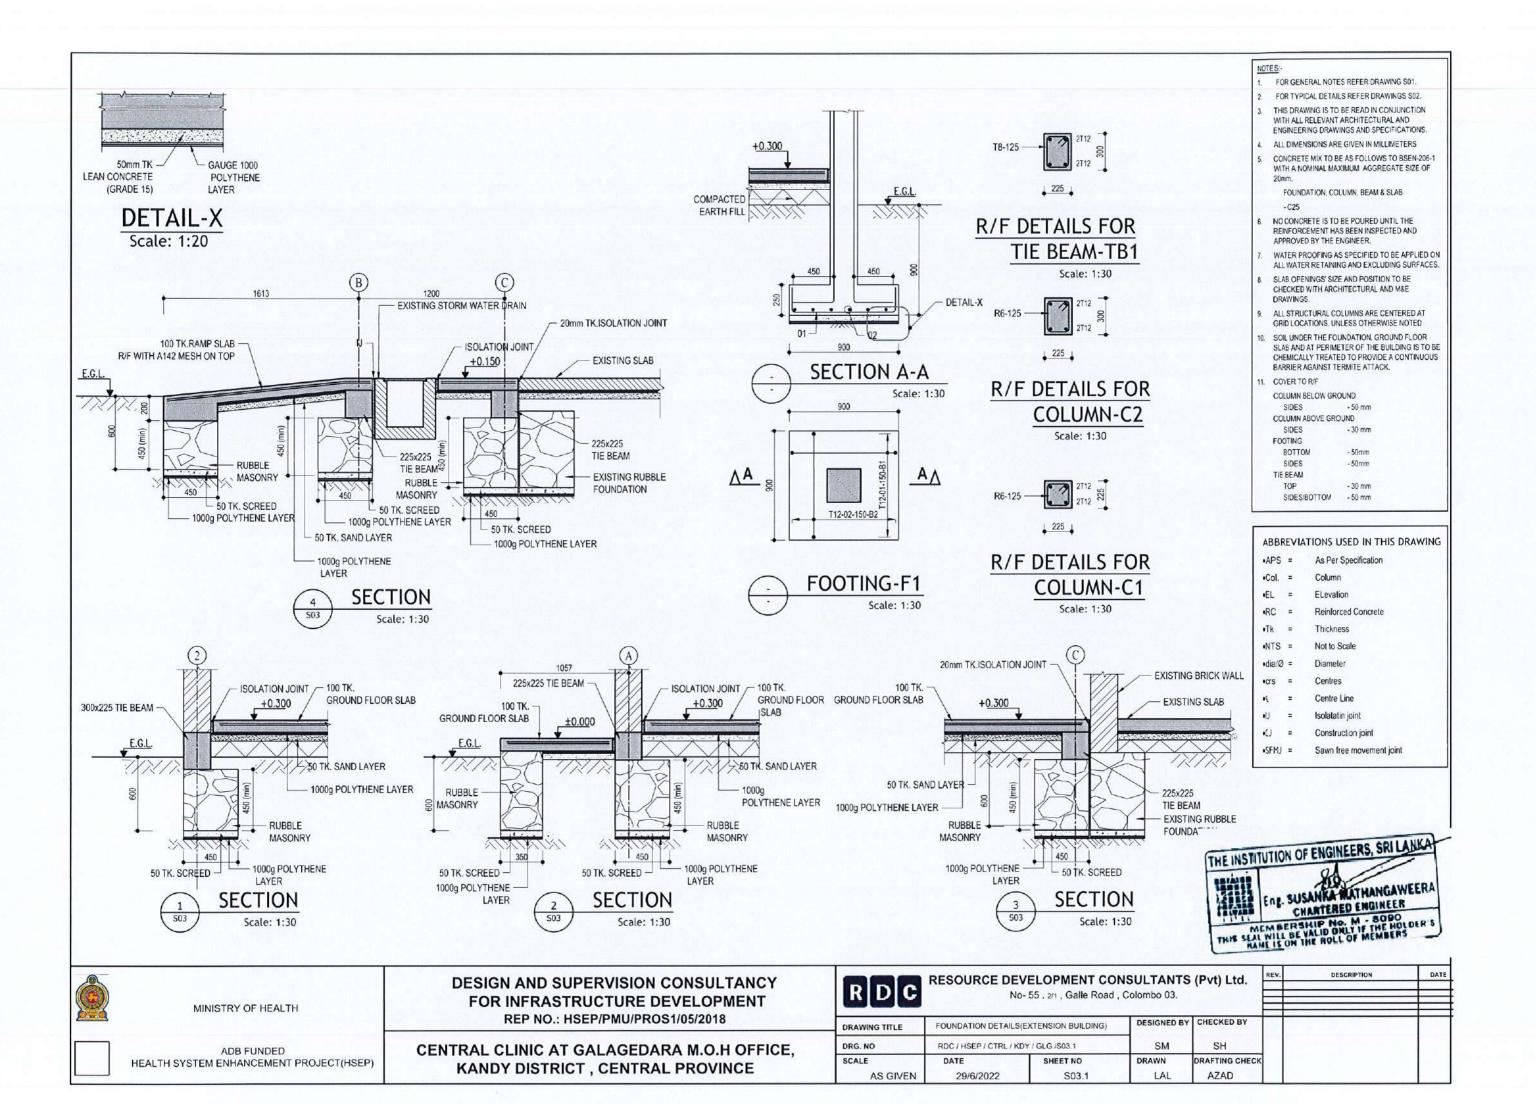

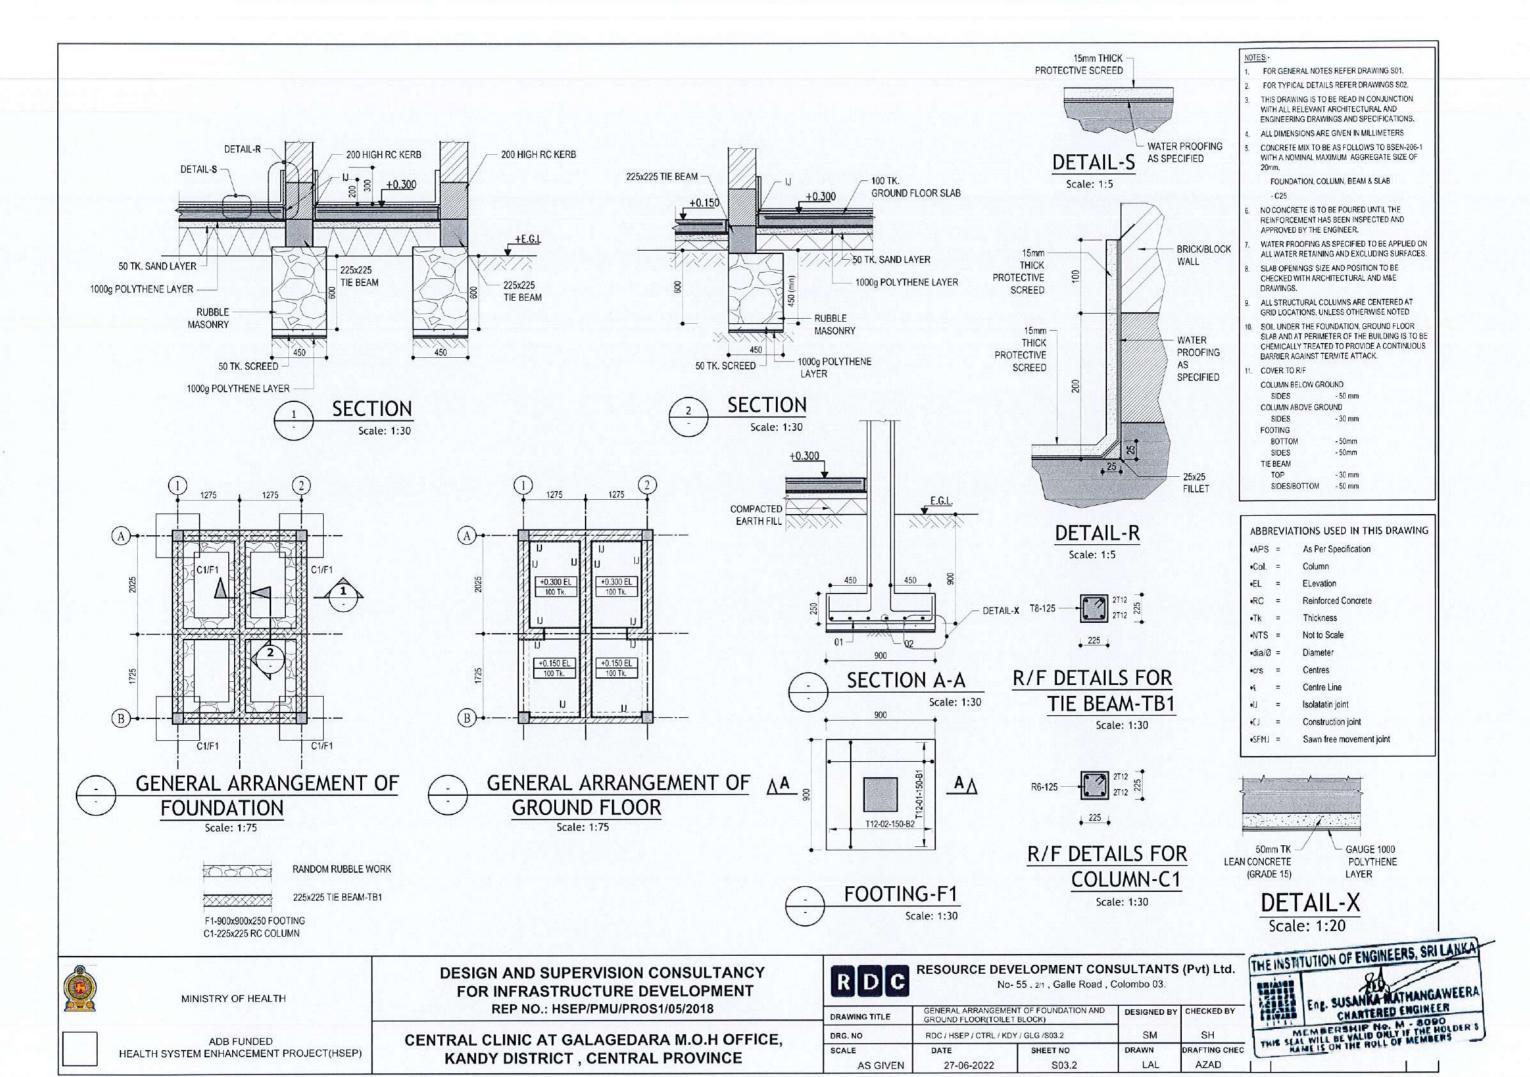

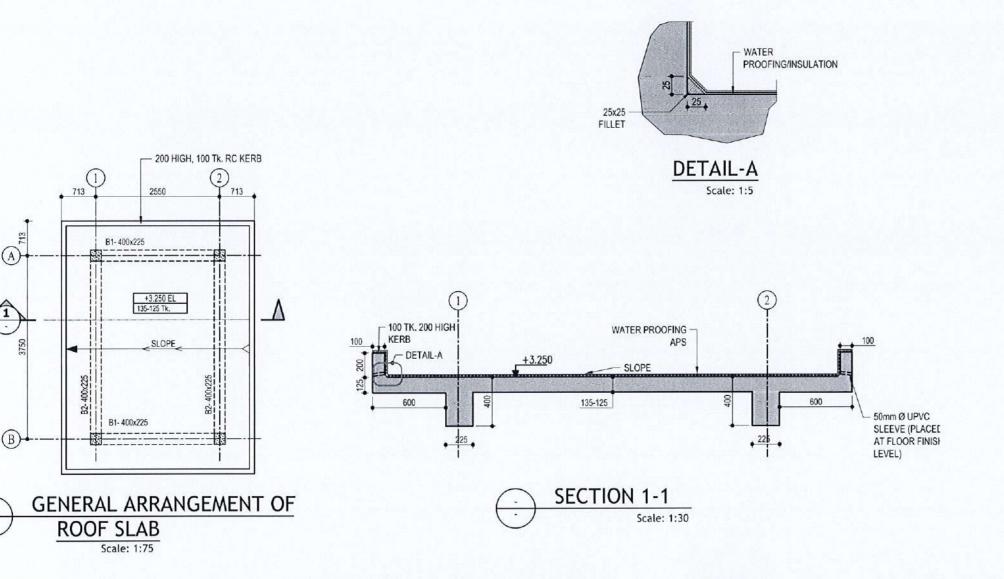

NOTES:-

- FOR GENERAL NOTES REFER DRAWING S01.
- FOR TYPICAL DETAILS REFER DRAWINGS \$02.
- THIS DRAWING IS TO BE READ IN CONJUNCTION WITH ALL RELEVANT ARCHITECTURAL AND ENGINEERING DRAWINGS AND SPECIFICATIONS.
- ALL DIMENSIONS ARE GIVEN IN MILLIMETERS
- CONCRETE MIX TO BE AS FOLLOWS TO BSEN-206-1 WITH A NOMINAL MAXIMUM AGGREGATE SIZE OF

FOUNDATION, COLUMN, BEAM & SLAB

- NO CONCRETE IS TO BE POURED UNTIL THE REINFORCEMENT HAS BEEN INSPECTED AND APPROVED BY THE ENGINEER.
- WATER PROOFING AS SPECIFIED TO BE APPLIED ON ALL WATER RETAINING AND EXCLUDING SURFACES.
- SLAB OPENINGS' SIZE AND POSITION TO BE CHECKED WITH ARCHITECTURAL AND M&E
- ALL STRUCTURAL COLUMNS ARE CENTERED AT GRID LOCATIONS, UNLESS OTHERWISE NOTED
- SOIL UNDER THE FOUNDATION, GROUND FLOOR SLAB AND AT PERIMETER OF THE BUILDING IS TO BE CHEMICALLY TREATED TO PROVIDE A CONTINUOUS BARRIER AGAINST TERMITE ATTACK.
- . COVER TO R/F

COLUMN BELOW GROUND

- 50 mm SIDES COLUMN ABOVE GROUND

- 30 mm SIDES

FOOTING

BOTTOM

SIDES - 50mm TIE BEAM

- 30 mm TOP SIDES/BOTTOM - 50 mm

ABBREVIATIONS USED IN THIS DRAWING

·APS = As Per Specification

Column

•EL ELevation

Reinforced Concrete

•Tk Thickness

•NTS = Not to Scale


•dia/Ø = Diameter

•crs Centres

Centre Line

Construction joint

Sawn free movement joint

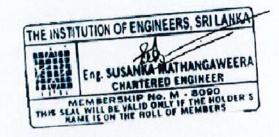



MINISTRY OF HEALTH

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CENTRAL CLINIC AT GALAGEDARA M.O.H OFFICE, KANDY DISTRICT, CENTRAL PROVINCE


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R	D	C	

RESOURCE DEVELOPMENT CONSULTANTS (Pvt) L

No- 55 . 2/1 , Galle Road , Colombo 03.

GENERAL ARRANGEMENT OF ROOF SLAB (TOILET BLOCK) DESIGNED BY CHECKED DRAWING TITLE SM SH DRG. NO RDC / HSEP / CTRL / KDY / GLG /S03.3 SCALE RAFTING DRAWN DATE SHEET NO LAL AZAD S03.3 AS GIVEN 27-06-2022

td.	REV.	DESCRIPTION	DATE
BY			
CHEC	K		

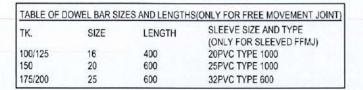

NOTE-1

- GROUND FLOOR SLAB TO BE PROVIDED WITH ISOLATION JOINTS AROUND COLUMNS/WALLS AND ALONG EDGES/ENDS OF MASONRY WALLS
- UNLESS OTHERWISE INDICATED SFMJ'S JOINTS SHALL BE PROVIDED COVERING AN AREA OF 6mX6m FOR SLABS ON GRADE

NOTE-2 - CONSTRUCTION/CONTRACTION JOINT.

- THE DOWELS TO BE MADE HORIZONTAL AND PERPENDICULAR TO THE JOINT PRIOR TO CONCRETING
- CARE SHOULD BE TAKEN ENSURE THE DOWELS ARE NOT DISTURBED DURING CONCRETING.


SPECIFICATION FOR LATERITIC GRAVEL TO BE USED AS BACK FILL MATERIAL.

LL	PI	MDD	CBR	COMPACTION
(%)	(%)	(kg/m)	(%)	
<40	<15	>1600	8-20	95% MDD

LL-LIQUID LIMIT PI-PLASTIC INDEX

MDD-MAXIMUM DRY DENSITY FROM PROCTOR TEST

CBR-CALIFORNIA BEARING RATIO

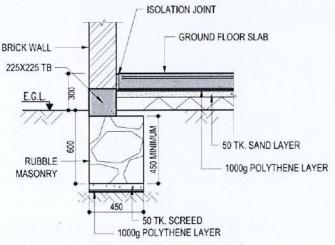


(SCALE- 1:30)

JOINT FORMATION NOTE-4

SAWN FREE MOVEMENT JOINTS ARE TO BE PROVIDED BY 6mm SAW CUT AFTER CONCRETE SUFFICIENTLY HARDENED AND

PREFERABLY WITHIN 24 HOURS AFTER PLACING OF CONCRETE.

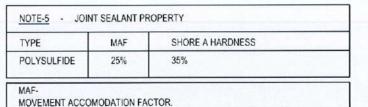

RC COLUMN/RC WALLS/ MASONRY WALL


10mm WIDE JOINT FILLED WITH

BACKER ROD & APPROVED SEALANT ON TOP

- 1000g POLYTHENE LAYER


PROPERLY COMPACTED

SUBGRADE

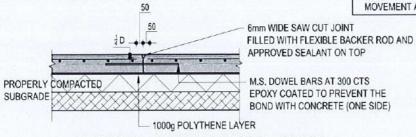

TYPICAL SECTION THRO. SAWN FREE MOVEMENT JOINT (SFMJ)

(SCALE- 1:30) D-DEPTH OF SLAB

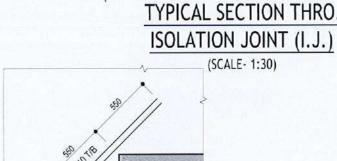

TYPICAL R/F DETAIL FOR

SLAB ON GRADE AT RE-ENTRANT

PLACED WITH FLEXIBLE BACKER ROD AND WITH 20mm DEEP APPROVED SEALANT ON TOP

10mm WIDE FORMED JOINT

M.S. DOWEL BARS AT 300 CTS EPOXY COATED TO PREVENT THE BOND WITH CONCRETE (HOT DIPPED GALVANIZED IF SLEEVED)

GROUND FLOOR SLAB

50 TK. SAND LAYER

TYPICAL SECTION THRO. FORMED FREE MOVEMENT JOINT (FFMJ)

- 1000g POLYTHENE LAYER

PROPERLY COMPACTED

BRICK WALL

225X225 TB

RUBBLE

MASONRY

SUBGRADE

(SCALE- 1:30)

ISOLATION JOINT

CORNER (SCALE- 1:30) ISOLATION JOINT **GROUND FLOOR SLAB BRICK WALL** 225X225 TB 1000g POLYTHENE LAYER 50 TK. SAND LAYER RUBBLE 1000g POLYTHENE LAYER MASONRY - 50 TK. SCREED 1000g POLYTHENE LAYER

TYPICAL RUBBLE FOUNDATION FOR 100/150 INTERNAL WALL

(SCALE- 1:30)


NOTES:-


- FOR GENERAL NOTES REFER DRAWING \$01
- FOR TYPICAL DETAILS REFER DRAWINGS S02. THIS DRAWING IS TO BE READ IN CONJUNCTION WITH ALL RELEVANT ARCHITECTURAL AND ENGINEERING DRAWINGS AND
- ALL DIMENSIONS ARE GIVEN IN MILLIMETERS
- CONCRETE MIX TO BE AS FOLLOWS TO BSEN-206-1 WITH A NOMINAL MAXIMUM AGGREGATE SIZE OF 20mm.

GROUND FLOOR SLAB

SPECIFICATIONS.

- NO CONCRETE IS TO BE POURED UNTIL THE REINFORCEMENT HAS BEEN INSPECTED AND APPROVED BY THE ENGINEER.
- WATER PROOFING AS SPECIFIED TO BE APPLIED ON ALL WATER RETAINING AND EXCLUDING SURFACES.
- SLAB OPENINGS' SIZE AND POSITION TO BE CHECKED WITH ARCHITECTURAL AND M&E DRAWINGS.
- ALL STRUCTURAL COLUMNS ARE CENTERED AT GRID LOCATIONS, UNLESS OTHERWISE NOTED
- SOIL UNDER THE FOUNDATION, GROUND FLOOR SLAB AND AT PERIMETER OF THE BUILDING IS TO BE CHEMICALLY TREATED TO PROVIDE A CONTINUOUS BARRIER AGAINST TERMITE ATTACK.
- COVER TOR/F AS FOLLOWS

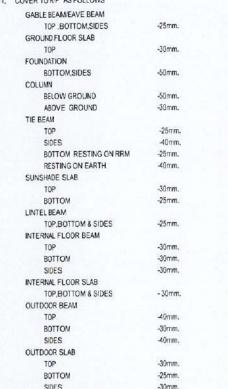

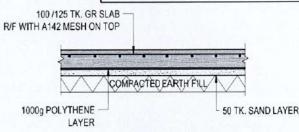

TYPICAL SECTION THRO. **GROUND FLOOR**

(CCALE 1.20)

TYPICAL RUBBLE FOUNDATION OF EXTERNAL WALL(200 TK.) (UNLESS OTHERWISE INDICATED)

MINISTRY OF HEALTH

ADB FUNDED HEALTH SYSTEM ENHANCEMENT PROJECT(HSEP)

DESIGN AND SUPERVISION CONSULTANCY FOR INFRASTRUCTURE DEVELOPMENT REP NO.: HSEP/PMU/PROS1/05/2018

50 TK. SCREED

1000g POLYTHENE LAYER

TYPICAL RUBBLE FOUNDATION

OF INTERNAL WALL(200 TK.)

(UNLESS OTHERWISE INDICATED)

(SCALE- 1:30)


CENTRAL CLINIC AT GALAGEDARA M.O.H OFFICE, KANDY DISTRICT, CENTRAL PROVINCE





RESOURCE DEVELOPMENT CONSULTANTS (Pvt) Ltd.


No- 55, 2/1, Galle Road, Colombo 03.


DRAWING TITLE	TYPICAL FOUNDATION DETAILS RDC / HSEP / CTRL / KDY / GLG /S03.4		VING TITLE TYPICAL FOUNDATION DETAILS		DESIGNED BY	CHECKED BY
DRG. NO			SM	SH		
SCALE	DATE	SHEET NO	DRAWN	DRAFTING CHEC		
AS GIVEN	29/6/2022	\$03.4	LAL	AZAD		

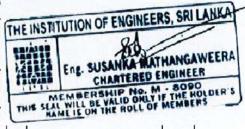

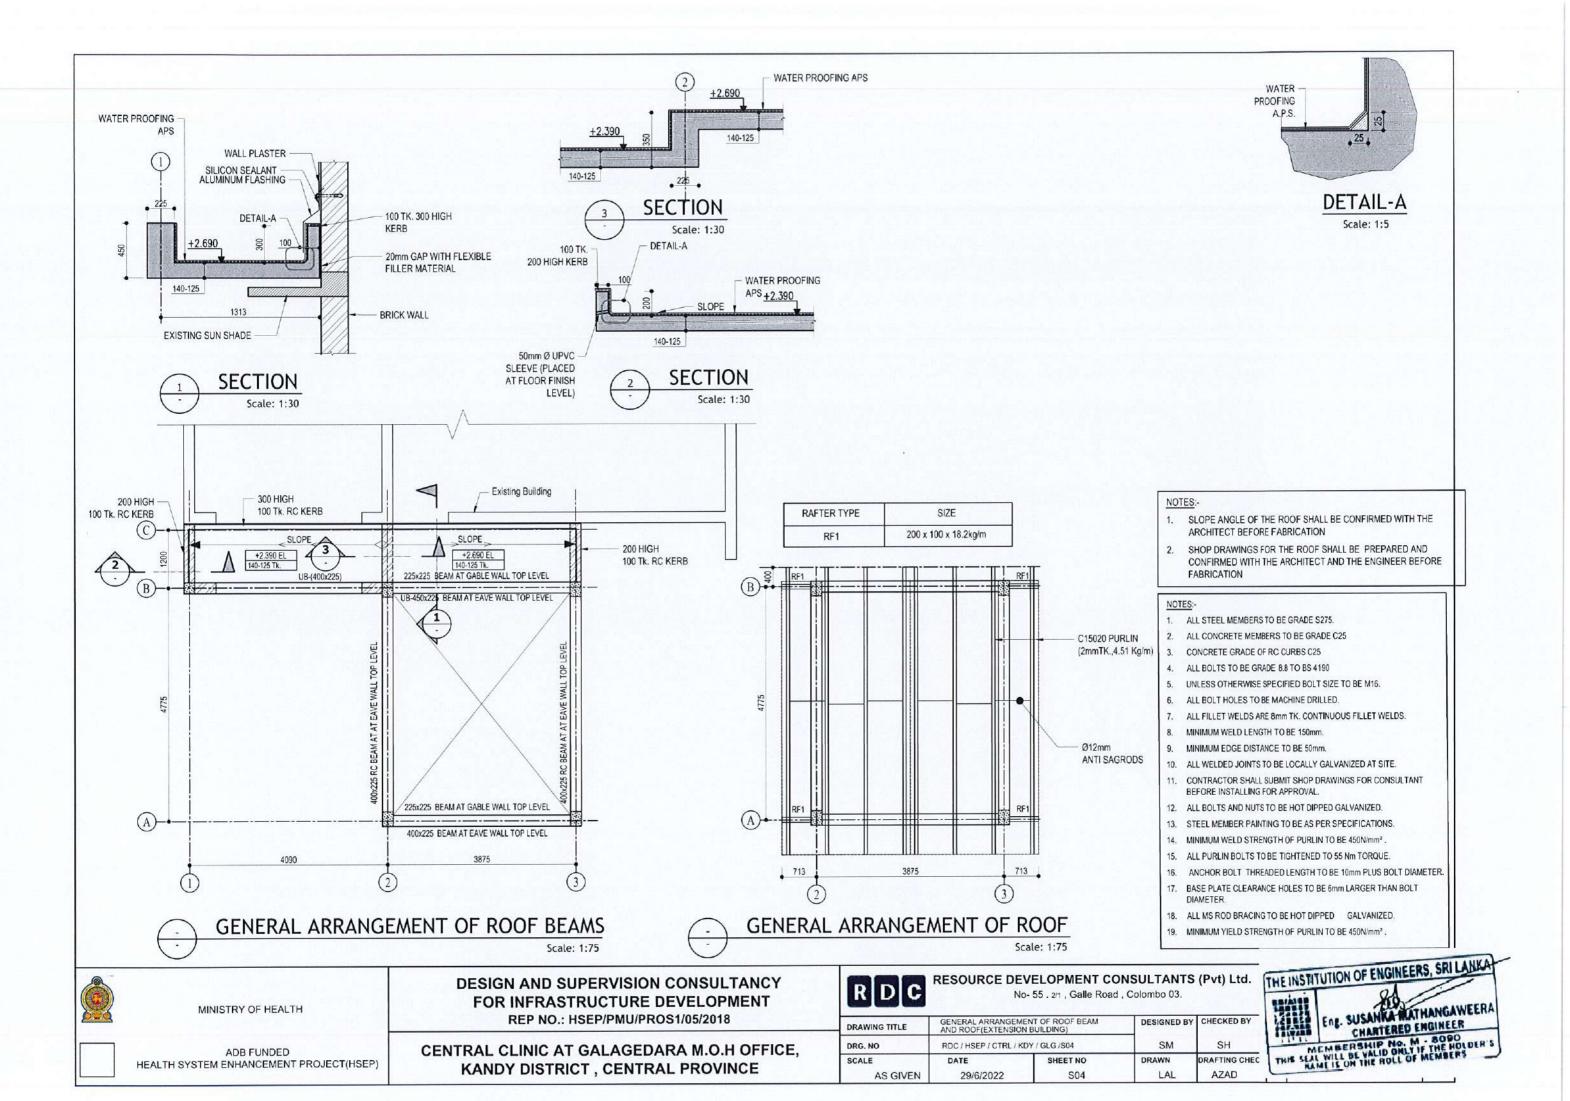

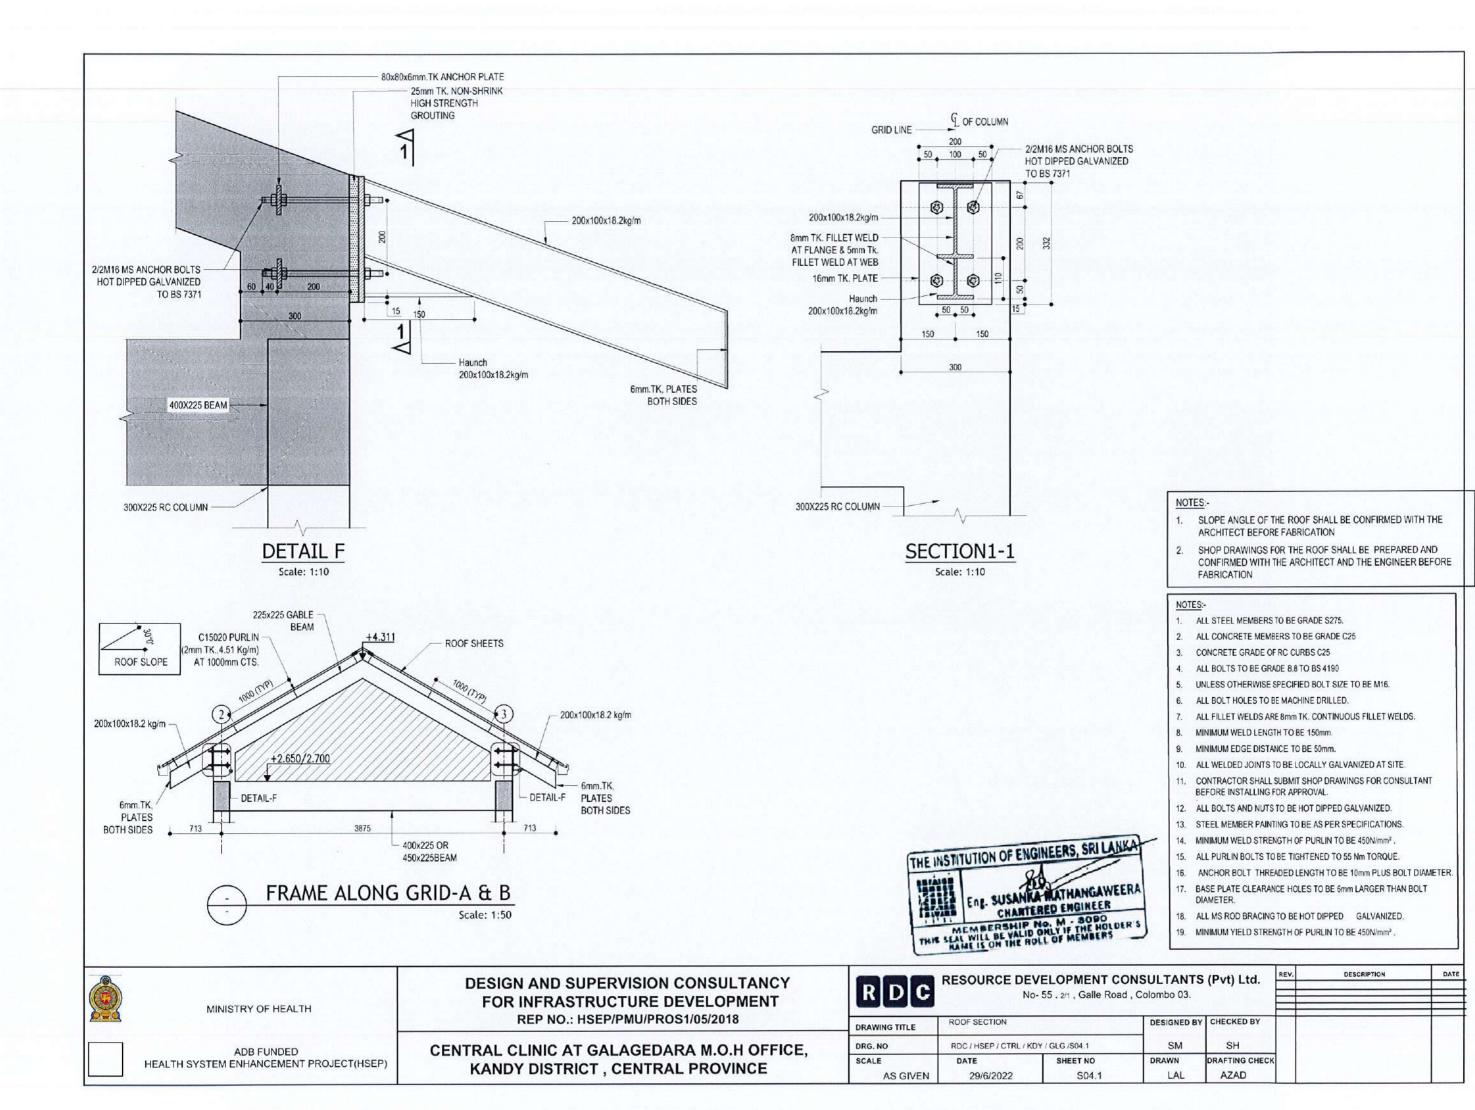


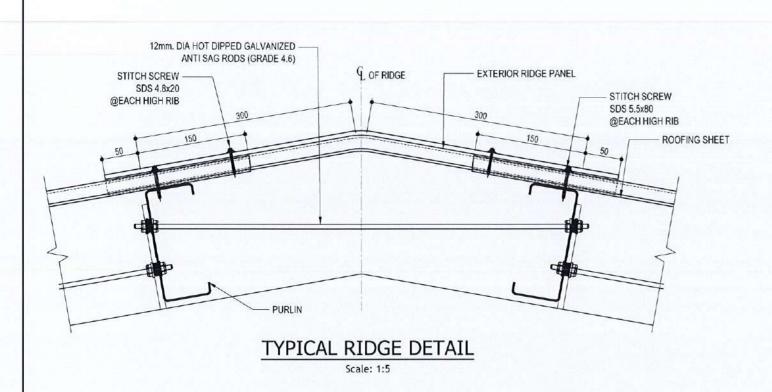

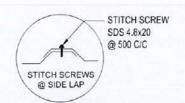

ROOF SHEET LAP DETAIL

Scale: 1:5

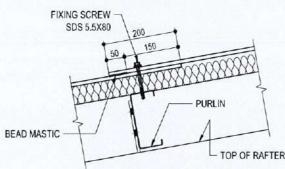

ROOF SHEET OVERLAP DETAILS

Scale: 1:10


NOTES:-

- ALL STEEL MEMBERS TO BE GRADE \$275.
- ALL CONCRETE MEMBERS TO BE GRADE C25
- CONCRETE GRADE OF RC CURB\$ C25
- ALL BOLTS TO BE GRADE 8.8 TO BS 4190
- UNLESS OTHERWISE SPECIFIED BOLT SIZE TO BE M16.
- ALL BOLT HOLES TO BE MACHINE DRILLED.
- ALL FILLET WELDS ARE 8mm TK. CONTINUOUS FILLET WELDS
- MINIMUM WELD LENGTH TO BE 150mm.
- MINIMUM EDGE DISTANCE TO BE 50mm
- 10. ALL WELDED JOINTS TO BE LOCALLY GALVANIZED AT SITE.
- CONTRACTOR SHALL SUBMIT SHOP DRAWINGS FOR CONSULTANT BEFORE INSTALLING FOR APPROVAL.
- 12. ALL BOLTS AND NUTS TO BE HOT DIPPED GALVANIZED.
- 13. STEEL MEMBER PAINTING TO BE AS PER SPECIFICATIONS.
- MINIMUM WELD STRENGTH OF PURLIN TO BE 450N/mm²
- ALL PURLIN BOLTS TO BE TIGHTENED TO 55 Nm TORQUE
- ANCHOR BOLT THREADED LENGTH TO BE 10mm PLUS BOLT DIAMETER
- BASE PLATE CLEARANCE HOLES TO BE 6mm LARGER THAN BOLT DIAMETER.
- 18. ALL MS ROD BRACING TO BE HOT DIPPED GALVANIZED
- 19. MINIMUM YIELD STRENGTH OF PURLIN TO BE 450N/mm²

NOTES:

- SLOPE ANGLE OF THE ROOF SHALL BE CONFIRMED WITH THE ARCHITECT BEFORE FABRICATION
- SHOP DRAWINGS FOR THE ROOF SHALL BE PREPARED AND CONFIRMED WITH THE ARCHITECT AND THE ENGINEER BEFORE FABRICATION

GUTTER STRAP FASTENER

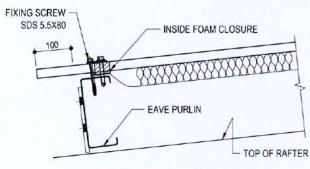

EAVE PURLIN DETAILS

Scale: 1:10

C15020 PURLIN (2.0TK.,4.51 Kg/m)


GALVANIZED

18x22 SIZE HOLES

HOLE DETAIL &

GAUGE LINE


Scale: 1:10

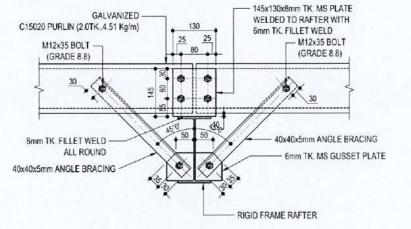


TYP. FLANGE BRACING DETAIL

Scale: 1:10

- ALL BOLTS ARE M12 UNLESS OTHERWISE
- THIS BRACING TO BE PROVIDED TO BOTH FIRST & SECOND PURLINS AT BOTH SIDES OF SUPPORTS COLUMNS ALONG ROOF RIDGE LINE.
- FOR OTHER AREA EVERY ALTERNATIVE PURLIN TO BE PROVIDED WITH THIS BRACING INCLUDING EAVE PURLIN.

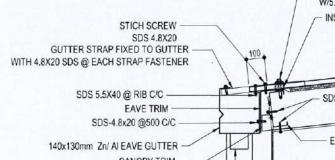

- SLOPE ANGLE OF THE ROOF SHALL BE CONFIRMED WITH THE ARCHITECT BEFORE FABRICATION
- SHOP DRAWINGS FOR THE ROOF SHALL BE PREPARED AND CONFIRMED WITH THE ARCHITECT AND THE ENGINEER BEFORE FABRICATION

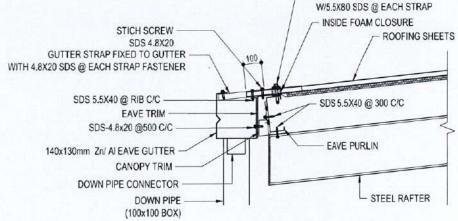

TYP. GUTTER FIXING

DETAIL Scale: 1:20

NOTE:- GUTTER LAP TO BE 150mm SEALED WITH BED MASTIC.

SDS - SELF DRILLING SCREW



MINISTRY OF HEALTH

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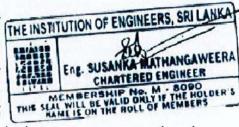
CENTRAL CLINIC AT GALAGEDARA M.O.H OFFICE, KANDY DISTRICT, CENTRAL PROVINCE




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No- 55, 2/1, Galle Road, Colombo 03.

DRAWING TITLE	ROOF DETAILS -1		DESIGNED BY	CHECKED BY	١
DRG. NO	RDC / HSEP / CTRL / KDY / GLG /S04.2		SM	SH	1
SCALE AS GIVEN	DATE 29/6/2022	SHEET NO	DRAWN LAL	DRAFTING CHEC	1
AS GIVEN	29/0/2022	S04.2	LAL	AZAD	L



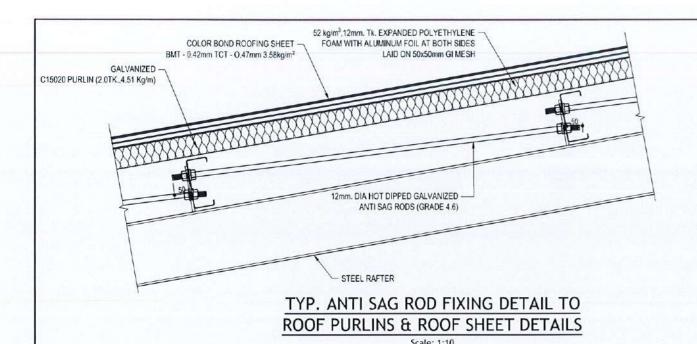


NOTES

- ALL STEEL MEMBERS TO BE GRADE \$275.
- ALL CONCRETE MEMBERS TO BE GRADE C25
- 3. CONCRETE GRADE OF RC CURBS C25
- 4. ALL BOLTS TO BE GRADE 8.8 TO BS 4190
- 5. UNLESS OTHERWISE SPECIFIED BOLT SIZE TO BE M16.
- 6. ALL BOLT HOLES TO BE MACHINE DRILLED.
- 7. ALL FILLET WELDS ARE 8mm TK. CONTINUOUS FILLET WELDS.
- 8. MINIMUM WELD LENGTH TO BE 150mm.
- 9. MINIMUM EDGE DISTANCE TO BE 50mm
- 10. ALL WELDED JOINTS TO BELOCALLY GALVANIZED AT SITE.
- 11. CONTRACTOR SHALL SUBMIT SHOP DRAWINGS FOR CONSULTANT BEFORE INSTALLING FOR APPROVAL.
- 12. ALL BOLTS AND NUTS TO BE HOT DIPPED GALVANIZED.
- 13. STEEL MEMBER PAINTING TO BE AS PER SPECIFICATIONS.
- 14. MINIMUM WELD STRENGTH OF PURLIN TO BE 450N/mm²
- 15. ALL PURLIN BOLTS TO BE TIGHTENED TO 55 Nm TORQUE.
- 10. ALL I GIVEN DOLLO TO BE HOTTENED TO SO HIM TOTAGE.
- ANCHOR BOLT THREADED LENGTH TO BE 10mm PLUS BOLT DIAMETER
 BASE PLATE CLEARANCE HOLES TO BE 6mm LARGER THAN BOLT
- 17. BASE PLATE CLEARANCE HOLES TO BE 6mm LARGER THAN BOU DIAMETER.
- 18. ALL MS ROD BRACING TO BE HOT DIPPED GALVANIZED.
- 19. MINIMUM YIELD STRENGTH OF PURLIN TO BE 450N/mm²

NOTES

- SLOPE ANGLE OF THE ROOF SHALL BE CONFIRMED WITH THE ARCHITECT BEFORE FABRICATION
- 2. SHOP DRAWINGS FOR THE ROOF SHALL BE PREPARED AND CONFIRMED WITH THE ARCHITECT AND THE ENGINEER BEFORE FABRICATION

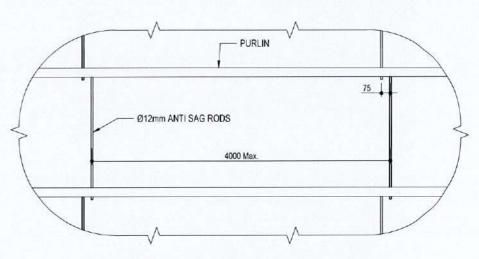


DETAIL OF ANTI SAG ROD SPACING

Scale: 1:30

NOTE:

Ø12mm ANTI SAG RODS TO FIXED FOR PURLINS AT A SPACING NOT GREATER THAN 20 TIMES OF PURLIN.

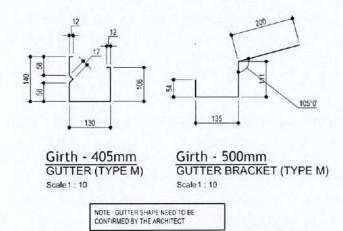

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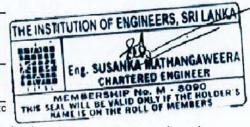
CENTRAL CLINIC AT GALAGEDARA M.O.H OFFICE, KANDY DISTRICT, CENTRAL PROVINCE




RESOURCE DEVELOPMENT CONSULTANTS (Pvt) Ltd.


No- 55 . 2/1 , Galle Road , Colombo 03.

DRAWING TITLE	ROOF DETAILS-2		DESIGNED BY	CHECKED BY	
DRG. NO	RDC / HSEP / CTRL / KDY / GLG /S04.3		SM	SH	1
SCALE	DATE	SHEET NO	DRAWN	DRAFTING CHEC	1
AS GIVEN	29/6/2022	S04.3	LAL	AZAD	ľ



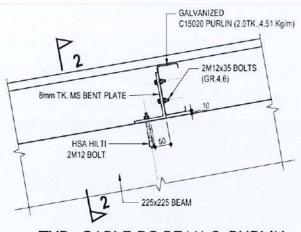


TYP. GABLE RC BEAM & PURLIN CONNECTION DETAIL

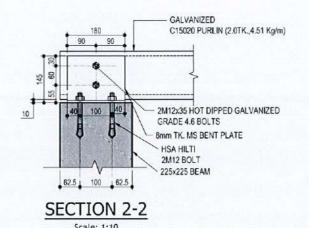

- ALL STEEL MEMBERS TO BE GRADE \$275.
- 2. ALL CONCRETE MEMBERS TO BE GRADE C25
- 3. CONCRETE GRADE OF RC CURBS C25
- 4. ALL BOLTS TO BE GRADE 8.8 TO BS 4190
- 5. UNLESS OTHERWISE SPECIFIED BOLT SIZE TO BE M16.
- 6. ALL BOLT HOLES TO BE MACHINE DRILLED.
- ALL FILLET WELDS ARE 8mm TK. CONTINUOUS FILLET WELDS.
- MINIMUM WELD LENGTH TO BE 150mm.
- 9. MINIMUM EDGE DISTANCE TO BE 50mm.
- 10. ALL WELDED JOINTS TO BE LOCALLY GALVANIZED AT SITE.
- 11. CONTRACTOR SHALL SUBMIT SHOP DRAWINGS FOR CONSULTANT BEFORE INSTALLING FOR APPROVAL.
- 12. ALL BOLTS AND NUTS TO BE HOT DIPPED GALVANIZED.
- 13. STEEL MEMBER PAINTING TO BE AS PER SPECIFICATIONS.
- 14. MINIMUM WELD STRENGTH OF PURLIN TO BE 450N/mm²
- ALL PURLIN BOLTS TO BE TIGHTENED TO 55 Nm TORQUE
- ANCHOR BOLT THREADED LENGTH TO BE 10mm PLUS BOLT DIAMETER
- BASE PLATE CLEARANCE HOLES TO BE 6mm LARGER THAN BOLT DIAMETER.
- 18. ALL MS ROD BRACING TO BE HOT DIPPED GALVANIZED.
- 19. MINIMUM YIELD STRENGTH OF PURLIN TO BE 450N/mm²

NOTES:

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DIMENSIONS OF CEE PURLIN Mass per unit CATELOGUE NO. length kg/m 4.51 150 C15020

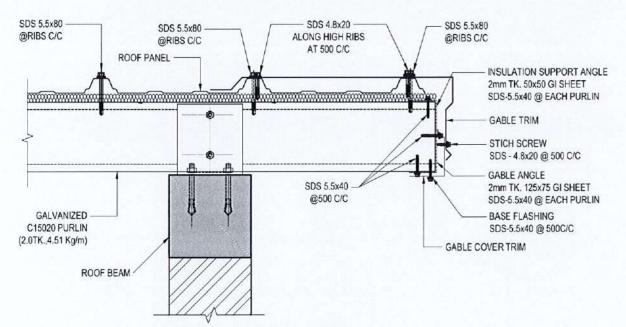TYP. GABLE CAPPING DETAILS

NOTE:

- ALL THE ROOFING SHEET TO PURLIN CONNECTIONS TO BE USING SDS 5.5X80
- ALL TRIM TO PURLIN/ GI ANGLE CONNECTIONS TO BE USING SDS 5.5X40
- ALL TRIM TO ROOFING SHEET/ TRIM CONNECTIONS TO BE USING SDS 4.8X20

MINISTRY OF HEALTH

ADB FUNDED HEALTH SYSTEM ENHANCEMENT PROJECT(HSEP) **DESIGN AND SUPERVISION CONSULTANCY** FOR INFRASTRUCTURE DEVELOPMENT REP NO.: HSEP/PMU/PROS1/05/2018

CENTRAL CLINIC AT GALAGEDARA M.O.H OFFICE, KANDY DISTRICT, CENTRAL PROVINCE

RIDIC

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No- 55 . 2/1 , Galle Road , Colombo 03.

DESCRIPTION


THE INSTITUTION OF ENGINEERS, SRI LANKA

THE SEAL WILL BE VALID ONLY IF THE HOLDER'S MAME IS ON THE ROLL OF MEMBERS

Eng. SUSANKA MATHANGAWEERA

CHARTERED ENGINEER

DRAWING TITLE	ROOF DETAILS-3	ROOF DETAILS-3		CHECKED BY	
DRG. NO	RDC / HSEP / CTRL / KDY / GLG /S04.4		SM	SH	
SCALE	DATE	SHEET NO	DRAWN	DRAFTING CHECK	
AS GIVEN	29/6/2022	S04.4	LAL	AZAD	

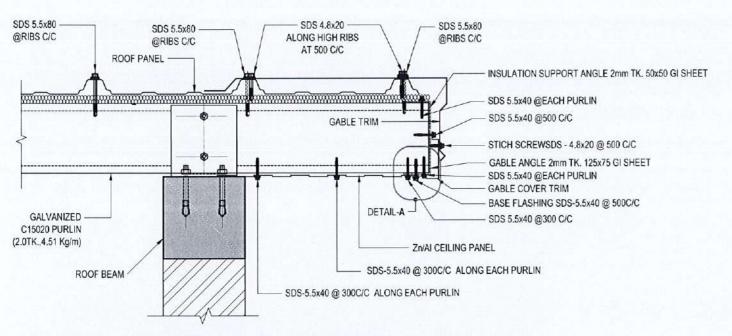

TYP. EXTERNAL CEILING FIXING DETAIL AT GABLE END


NOTE:

- ALL THE ROOFING SHEET TO PURLIN CONNECTIONS TO BE USING SDS 5.5X80
- ALL TRIM TO PURLIN/ GI ANGLE CONNECTIONS TO BE USING SDS 5.5X40
- ALL TRIM TO ROOFING SHEET/ TRIM CONNECTIONS TO BE USING SDS 4.8X20

NOTES:-

- ALL STEEL MEMBERS TO BE GRADE S275.
- ALL CONCRETE MEMBERS TO BE GRADE C25
- 3. CONCRETE GRADE OF RC CURBS C25
- 4. ALL BOLTS TO BE GRADE 8.8 TO BS 4190
- UNLESS OTHERWISE SPECIFIED BOLT SIZE TO BE M16.
- ALL BOLT HOLES TO BE MACHINE DRILLED.
- ALL FILLET WELDS ARE 8mm TK. CONTINUOUS FILLET WELDS.
- MINIMUM WELD LENGTH TO BE 150mm.
- MINIMUM EDGE DISTANCE TO BE 50mm.
- 10. ALL WELDED JOINTS TO BE LOCALLY GALVANIZED AT SITE.
- 11. CONTRACTOR SHALL SUBMIT SHOP DRAWINGS FOR CONSULTANT BEFORE INSTALLING FOR APPROVAL.
- 12. ALL BOLTS AND NUTS TO BE HOT DIPPED GALVANIZED.
- 13. STEEL MEMBER PAINTING TO BE AS PER SPECIFICATIONS.
- 14. MINIMUM WELD STRENGTH OF PURLIN TO BE 450N/mm²
- ALL PURLIN BOLTS TO BE TIGHTENED TO 55 Nm TORQUE.
- ANCHOR BOLT THREADED LENGTH TO BE 10mm PLUS BOLT DIAMETER.
- 17. BASE PLATE CLEARANCE HOLES TO BE 6mm LARGER THAN BOLT DIAMETER.
- ALL MS ROD BRACING TO BE HOT DIPPED GALVANIZED.
- 19. MINIMUM YIELD STRENGTH OF PURLIN TO BE 450N/mm²

- SLOPE ANGLE OF THE ROOF SHALL BE CONFIRMED WITH THE ARCHITECT BEFORE FABRICATION
- SHOP DRAWINGS FOR THE ROOF SHALL BE PREPARED AND CONFIRMED WITH THE ARCHITECT AND THE ENGINEER BEFORE FABRICATION

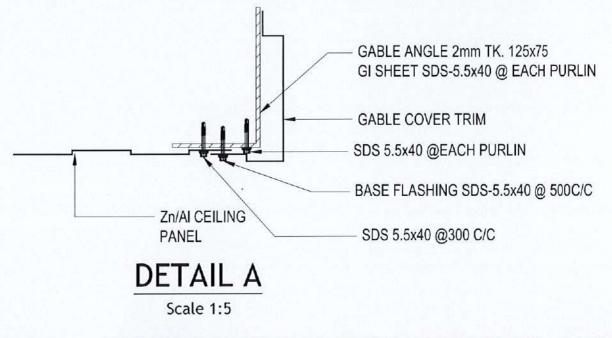



MINISTRY OF HEALTH


ADB FUNDED HEALTH SYSTEM ENHANCEMENT PROJECT(HSEP) **DESIGN AND SUPERVISION CONSULTANCY** FOR INFRASTRUCTURE DEVELOPMENT REP NO.: HSEP/PMU/PROS1/05/2018


CENTRAL CLINIC AT GALAGEDARA M.O.H OFFICE, KANDY DISTRICT, CENTRAL PROVINCE



RESOURCE DEVELOPMENT CONSULTANTS (Pvt) Ltd. No- 55, 2/1, Galle Road, Colombo 03.

DESIGNED BY CHECKED BY CEILING DETAILS-1 DRAWING TITLE RDC / HSEP / CTRL / KDY / GLG /S05 SH RAFTING CHECI SCALE DATE SHEET NO DRAWN AZAD LAL AS GIVEN 29/6/2022 S05

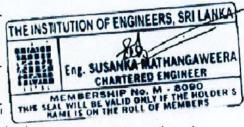

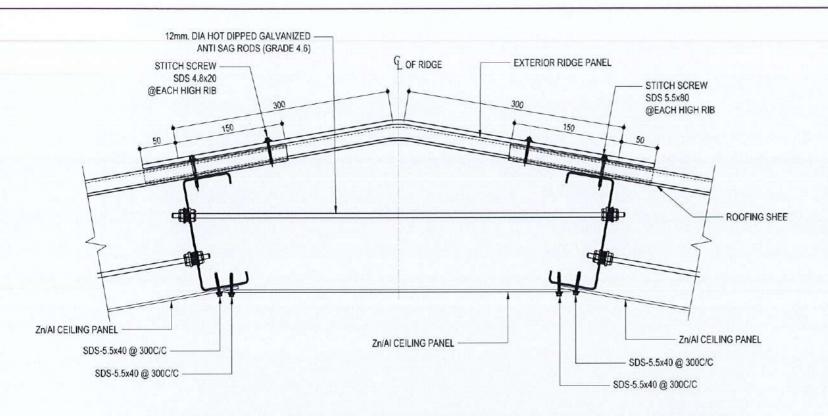

TYP. EXTERNAL CEILING FIXING DETAIL FOR RIDGE AT GABLE END

100×50×2 GI 5.5X80 SDS @ EACH RIB SHEET ANGLE C15020 PURLIN INSIDE FOAM CLOSURE SDS 5.5x80 @ EACH RIB -SDS 4.8x20 @ EACH STRAP C15020 PURLIN 50×50 2mm.TK,GI SHEETING ANGLE **GUTTER STRAP FIXED TO GUTTER** WITH 4.8X20 SDS @ EACH STRAP GABLE ANGLE 2mm TK. 125x75 GI SHEET SDS-5.5x40 @ EACH PURLIN SDS 5.5x40 @300 C/C SDS 5.5x40 Zn/AI CEILING PANEL SDS 5.5x40 @500 C/C -SDS 5.5x40 SDS 5.5x40@300 C/C FOR 100x50 2mm. TK, GI SHEETING ANGLE FIXING 140x130mm Zn/ AI EAVE GUTTER SDS 5.5x40@300 C/C FOR CEILING SHEET FIXING Zn/AI CLADDING PANEL SDS 5.5x40 SDS 5.5x40 Zn/AI CEILING PANEL SDS 5.5x40 @500 C/C SDS 5.5x40@ 300 C/C VERTICALLY FOR CEILING SHEET FIXING 50×50×2 GI SHEET ANGLE 50×50 2mm. TK, GI SHEETING ANGLE SDS 5.5x40 50×50×2 GI SHEET ANGLE SDS 5.5x80 @EACH RIB SDS 5.5x40 v SDS 5.5x40@ 300 C/C FOR CEILING SHEET FIXING SDS 4.8x20 @300 C/C 50×50×5 MS ANGLE SECTION 14-10 HEX HEAD TEKS WITH SEAL (CLASS-C4) @300 C/C SDS 5.5x40 SDS 5.5x40@300 C/C HORIZONTALLY FOR SDS 5.5x40 @300 C/C - Zn/Al CEILING PANEL CEILING SHEET FIXING TYP. EAVE CEILING FIXING AT GABLE EAVE - ELEVATION

NOTES:-

- ALL STEEL MEMBERS TO BE GRADE \$275.
- ALL CONCRETE MEMBERS TO BE GRADE C25
- CONCRETE GRADE OF RC CURBS C25
- ALL BOLTS TO BE GRADE 8.8 TO BS 4190
- UNLESS OTHERWISE SPECIFIED BOLT SIZE TO BE M16.
- ALL BOLT HOLES TO BE MACHINE DRILLED.
- ALL FILLET WELDS ARE 8mm TK. CONTINUOUS FILLET WELDS.
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THE INSTITUTION OF ENGINEERS, SRI LANKA CHARTERED ENGINEER THIS SEAL WILL BE VALID ONLY IF THE HOLDER'S HAME IS ON THE ROLL OF MEMBERS

DESCRIPTION

MINISTRY OF HEALTH

ADB FUNDED HEALTH SYSTEM ENHANCEMENT PROJECT(HSEP)

DESIGN AND SUPERVISION CONSULTANCY FOR INFRASTRUCTURE DEVELOPMENT


REP NO.: HSEP/PMU/PROS1/05/2018

CENTRAL CLINIC AT GALAGEDARA M.O.H OFFICE, KANDY DISTRICT, CENTRAL PROVINCE


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RESOURCE DEVELOPMENT CONSULTANTS (Pvt) Ltd.

KDC	No- 55 , 2/1 , Galle Road , Colombo 03.					
DRAWING TITLE	CEILING DETAILS-2		DESIGNED BY	CHECKED BY	Mileo Till Ville	
DRG. NO	RDC / HSEP / CTRL / F	KDY / GLG /S05.1	SM	SH		
SCALE AS GIVEN	DATE 29/6/2022	SHEET NO S05.1	DRAWN LAL	DRAFTING CHECK AZAD		

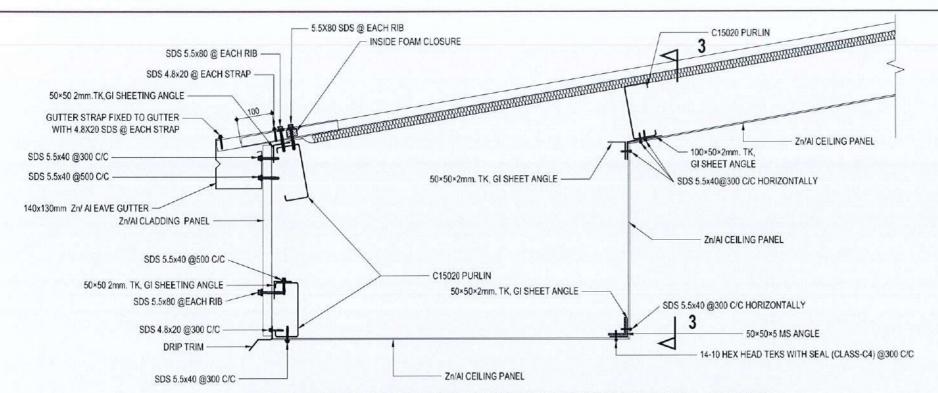

TYP. EAVE CEILING SHEET FIXING AT GABLE EAVE - SECTION

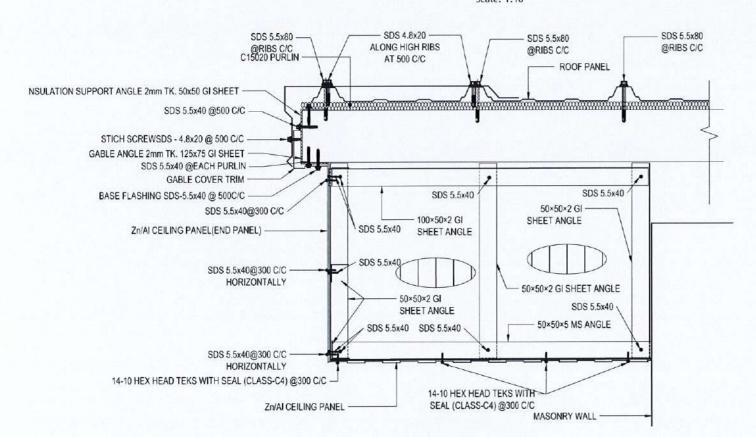

SECTION 3-3

NOTES:

- ALL STEEL MEMBERS TO BE GRADE S275.
- ALL CONCRETE MEMBERS TO BE GRADE C25
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THE INSTITUTION OF ENGINEERS, SRI LANKA Eng. SUSANKA MATHANGAWEERA CHARTERED ENGINEER THIS SEAL WILL BE VALID ONLY IF THE HOLDER'S HAME IS ON THE ROLL OF MEMBERS

DESCRIPTION

DATE

MINISTRY OF HEALTH

ADB FUNDED HEALTH SYSTEM ENHANCEMENT PROJECT(HSEP) **DESIGN AND SUPERVISION CONSULTANCY** FOR INFRASTRUCTURE DEVELOPMENT REP NO.: HSEP/PMU/PROS1/05/2018

CENTRAL CLINIC AT GALAGEDARA M.O.H OFFICE, KANDY DISTRICT, CENTRAL PROVINCE

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29/6/2022


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SCALE


RESOURCE DEVELOPMENT CONSULTANTS (Pvt) Ltd.

No- 55 . 2/1 , Galle Road , Colombo 03.

CHECKED BY DESIGNED BY CEILING DETAILS-3 RDC / HSEP / CTRL / KDY / GLG /S05.2 SH SHEET NO DRAWN RAFTING CHECK AZAD S05.2 LAL

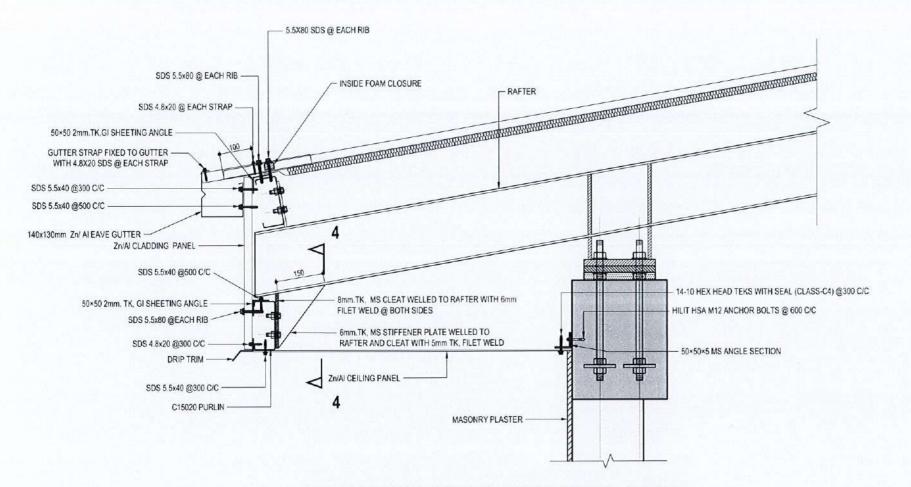

TYP. EXTERNAL CEILING FIXING DETAIL @ EAVE

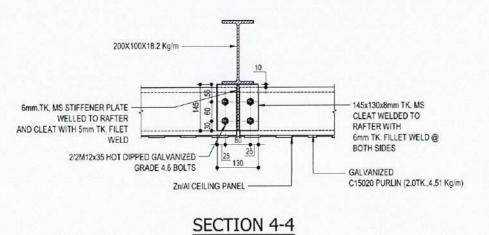

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THE INSTITUTION OF ENGINEERS, SRI LANKA ENE. SUSANKA MATHANGAWEERA CHARTERED ENGINEER THE SEAL WILL BE VALID ONLY IF THE HOLDER'S HAML IS ON THE ROLL OF MEMBERS



MINISTRY OF HEALTH

ADB FUNDED HEALTH SYSTEM ENHANCEMENT PROJECT(HSEP) **DESIGN AND SUPERVISION CONSULTANCY** FOR INFRASTRUCTURE DEVELOPMENT REP NO.: HSEP/PMU/PROS1/05/2018

CENTRAL CLINIC AT GALAGEDARA M.O.H OFFICE,

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RESOURCE DEVELOPMENT CONSULTANTS (Pvt) Ltd.

No- 55 . 2/1 , Galle Road , Colombo 03.

DESIGNED BY CHECKED BY

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KANDY DISTRICT, CENTRAL PROVINCE

DRAWING TITLE	CEILING DETAILS-1		DESIGN
DRG. NO	RDC / HSEP / CTRL /	KDY / GLG /S05.3	SM
SCALE	DATE	SHEET NO	DRAWN
AS GIVEN	29/6/2022	S05.3	LA

CEILING DETAILS-1

ELECTRICAL DRAWINGS FOR HEALTH SYSTEMS ENHANCEMENT PROJECT

CENTRAL CLINIC AT GALAGEDARA KANDY DISTRICT CENTRAL PROVINCE

PROPOSED TOILET BLOCK





MINISTRY OF HEALTH

ADB FUNDED HEALTH SYSTEM ENHANCEMENT PROJECT(HSEP) **DESIGN AND SUPERVISION CONSULTANCY** FOR INFRASTRUCTURE DEVELOPMENT REP NO.: HSEP/PMU/PROS1/05/2018

CENTRAL CLINIC AT GALAGEDARA M.O.H OFFICE, KANDY DISTRICT, CENTRAL PROVINCE

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TITLE PAGE		DESIGNED & CHECKED BY		
RDC/HSEP/CTRL/KDY/GLG/ EL-01		NP		
DATE 10/ 06/ 2022	SHEET NO 001	DRAWN BY DBE		
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ALE	DATE 10/ 06/ 2022	SHEET NO	DRAWN BY			

#	DRAWING NUMBER	DRAWING TITLE	SCALE
01	RDC / HSEP / CTRL / KDY / GLG/ EL-01	TITLE PAGE	
02	RDC / HSEP / CTRL / KDY /GLG/ EL-02	SCHEDULE OF DRAWINGS	
03	RDC / HSEP / CTRL / KDY / GLG / EL-03	ELECTRICAL LAYOUT PLAN & DISTRIBUTIONDIAGRAM	1:75



MINISTRY OF HEALTH

ADB FUNDED HEALTH SYSTEM ENHANCEMENT PROJECT(HSEP)

DESIGN AND SUPERVISION CONSULTANCY FOR INFRASTRUCTURE DEVELOPMENT REP NO.: HSEP/PMU/PROS1/05/2018


CENTRAL CLINIC AT GALAGEDARA M.O.H OFFICE, KANDY DISTRICT, CENTRAL PROVINCE




RESOURCE DEVELOPMENT CONSULTANTS (Pvt) Ltd.

No- 55 . 21 . Galle Road . Colombo 03

DRAWING TITLE	SCHEDULE OF DRAWINGS		DESIGNED & CHECKED BY	
DRG. NO	RDC / HSEP / CTRL / KDY	RDC/HSEP/CTRL/KDY/GLG/ EL-02		
SCALE	DATE 10/ 06/ 2022	SHEET NO 002	DRAWN BY	

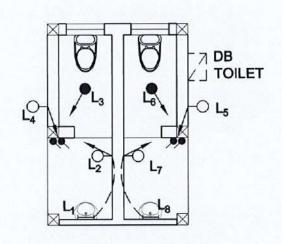

ELECTRICAL LAYOUT PLAN

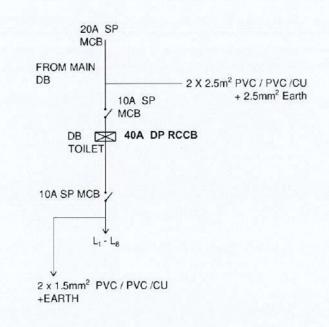

DISTRIBUTION DIAGRAM FOR DB

	LEGEND
TYPE	DESCRIPTION
	18W LED LAMPS
\boxtimes	25W LED LAMPS
•	12W LED
Ю	18W WALL LED LAMPS
B±	2 x13 AMP S S O
D-*	13 AMP SSO PER A/C
\vdash	22W MIRROR LAMPS
H	36W WALL LAMPS CFL
⊳⊲	CEILING FAN 56"
•	10 A SWITCH
2^	TWO WAY SWITCH
F.	FAN PLUG
T _A	TELE / DATA ROUTER
DB	DISTRIBUTION BOARD

THE INSTITUTION OF ENGINEERS, SRI LANKA

Eng. K N D PERERA

CHARTERED ENGINEER

MEMBERSHIP No. M - 1730

THIS SEAL WILL BE VALID ONLY IF THE HOLDER'S
HAME IS ON THE ROLL OF MEMBERS

MINISTRY OF HEALTH

ADB FUNDED HEALTH SYSTEM ENHANCEMENT PROJECT(HSEP) DESIGN AND SUPERVISION CONSULTANCY FOR INFRASTRUCTURE DEVELOPMENT REP NO.: HSEP/PMU/PROS1/05/2018

CENTRAL CLINIC AT GALAGEDARA M.O.H OFFICE, KANDY DISTRICT, CENTRAL PROVINCE

R D C	RESOURCE DEVELOPMENT CONSULTANTS (Pvt) Ltd. No- 55, 2/1, Galle Road, Colombo 03.		REV.	DESCRIPTION	DATE	
DRAWING TITLE	ELECTRICAL LAYOUT PLAN & DISTRIBUTION DIAGRAM		DESIGNED & CHECKED BY			
DRG. NO	RDC/HSEP/CTRL/KDY/GLG/ EL-03		NP			
SCALE 1:75	DATE 10/ 06/ 2022	SHEET NO	DRAWN BY			